COMMERCIAL BUILDING Hudson Check Cashing

73 Pleasant Street Extension Monticello, New York - Village of Monticello

ENERGY CONSERVATION CLIMATE & GEOGRAPHIC DESIGN CRITERIA ABBREVIATIONS & SYMBOLS THE NEW COMMERCIAL BUILDING DESCRIBED IN THESE DRAWINGS COMPLIES WITH ALL NEW YORK STATE CHAPTER 8 BUILDING DESIGN FOR COMMERCIAL BUILDINGS AS SPECIFIED IN SUBJECT TO DAMAGE FROM TABLE 802.2(6) BUILDING ENVELOPE REQUIREMENTS FOR CLIMATE ZONE 15, WINDOW & GLAZED GROUND SEISMIC ABOVE FINISH FLOOR DOOR AREA GREATER THAN 25% BUT NOT GREATER THAN 40% OF ABOVE-GRADE WALL AREA. SNOW DESIGN FROST LINE SPEED ALUM ALUMINUM WEATHERING **TERMITE** DECAY CATEGORY LOAD AMP AMPERE APPROX APPROXIMATELY SLIGHT TO MODERATE CEILING HEIGHT SLAB R-VALUE 50 PSF 90 MPH SEVERE 48 IN TO HEAVY MODERATE C.I.P. CAST IN PLACE WINDOWS U-FACTOR 0.4 MAX. 0.17 CLOSET GLASS DOORS U-FACTOR 0.4 MAX. 0.25 CMU CONCRETE MASONRY UNIT WOOD TRUSS ROOF R-VALUE R-30 MIN. R-46+ CONC CONCRETE ABOVE GRADE MASONRY WALL R-VALUE R-30+ (INCLUDING CERAMIC TILE BUILDING SECTION KEY THERMAL MASS) ARROW INDICATES DIRECTION OF VIEW DOUGLAS FIR DOWN DISHWASHER ELECTRIC / ELECTRICAL ELEV DRAWING LIST SITE PLAN ELEVATION EQUAL EXG EXISTING - DRAWING NUMBER INSULATED CONCRETE FORM FLOOR FEET GALV. GALVANIZED TO I TITLE SHEET GWB GYPSUM WALL BOARD - SHEETROCK DETAIL SECTION KEYS NEW CATCH BASIN — FENCED REFUSE AREA HOSE BIB - FROST FREE LOT LINE REVISION TO ARROW INDICATES DIRECTION OF VIEW LOI SITE, LIGHTING & LANDSCAPE PLANS & DETAILS HM HOLLOW METAL MERGE LOTS A & B ICFs INSULATED CONCRETE FORMS INSUL INSULATION AO I FIRST FLOOR PLAN, SCHEDULES & DETAILS INT. ELEV INTERIOR ELEVATION O.84 ACRE LED LIGHT EMITING DIODE SBL 107-1-8.1 LOT B AO2 ELEVATIONS LVL LAMINATED VENEER LUMBER DRAWING NUMBER 7 | 0.51 ACRE O.43 ACRE MARB MARBLE EXISTING PROPANE TANK SHEET NUMBER AO3 BUILDING SECTIONS & PLUMBING RISER DIAGRAMS SBL 107-1-10 SBL 107-1-9 MAX. MAXIMUM NEW TOE OF SLOPE - WITH NEW UNDERGROUND MECH MECHANICAL WITH SWALE SUPPLY TO NEW BUILDING A04 REFLECTED CEILING PLAN, INTERIOR ELEVATIONS \$ SITE PLAN DETAILS MILLIMETER NEW BUILDING -MIN. MINIMUM INTERIOR ELEVATION KEY M.O. MASONRY OPENING ARROWS INDICATE DIRECTION OF VIEW EXISTING FRONT, SIDE & REAR SO I FOUNDATION PLAN & DETAILED SECTION MR GWB MOISTURE RESISTANT GYPSUM WALL BOARD YARD SETBACKS N.I.C. NOT IN CONTRACT SO2 ROOF & CEILING JOIST FRAMING PLANS N.T.S. NOT TO SCALE O.C. ON CENTER OSB ORIENTED STRAND BOARD DOOR KEY EO I FIRST FLOOR ELECTRICAL PLAN PLY PLYWOOD POLY POLYURETHANE P.O.S. POINT OF SUPPORT PREP WINDOW KEY NEW LIGHT POLE -POUNDS PER SQUARE FOOT PSI POUNDS PER SQUARE INCH NEW PAVEMENT & CURB -PRESSURE TREATED REQ. REQUIRED GENERAL NOTES ROOM NUMBER R.O. ROUGH OPENING R.O.B RUN OF BANK SQUARE FEET NEW SIGN WITH DOWNLIGHTING -KEYED NOTE SPRUCE-PINE-FIR TBD PLEASANT STREET EXT. TO BE DETERMINED T#G TONGUE & GROOVE I. DO NOT SCALE DRAWINGS. THRU THROUGH TYPICAL 2. ALL MATERIALS AND METHODS OF CONSTRUCTION NOT EXTEND EXISTING MUNICIPAL VCB VINYL COVE BASE SPECIFICALLY ADDRESSED IN THESE DRAWINGS AND WATER & SEWER TO NEW BUILDING VSF VINYL SHEET FLOORING SPECIFICATIONS SHALL COMPLY WITH THE MINIMUM

STANDARDS OF THE BUILDING CODE OF NEW YORK STATE,

MONTICELLO, THE SULLIVAN COUNTY DEPARTMENT OF HEALTH

THE NYS ENERGY CONSERVATION CODE, THE VILLAGE OF

3. CONTRACTOR IS RESPONSIBLE FOR THE REMOVAL FROM THE

AND THE NYS BOARD OF FIRE UNDERWRITERS.

SITE OF ALL CONSTRUCTION DEBRIS.

V.I.F.

WD

W.W.M.

VERIFY IN FIELD

WOVEN WIRE MEST

WITH

WOOD

COMMERCIAL BUILDING

FOR

HUDSON CHECK CASHING

73 PLEASANT STREET EXT. MONTICELLO. NEW YORK

VILLAGE OF MONTICELLO

IF THESE PLANS HAVE BEEN AFFIXED WITH THE SEAL OF A LICENSED ARCHITEC

REVISION	DATE	DESCRIPTION

BOLDER ARCHITECTURE

ICE SHIIELD

REQUIRED

1507.2.8.2

INDERLAYMENT

DESIGN

EMPERATURE

ZONE B I

— EXISTING PAVEMENT

— EXISTING BUILDING

EXISTING

BASINS

EXISTING

SIGNAL POLE

EXISTING

CATCH BASIN

- CATCH

L EXISTING SIDEWALK

OF MONTICELLO, NY, DATED FEBRUARY 11, 2008,

THIS SITE PLAN, BASED ON A SURVEY BY JOHN GALLIGAN, LLS

IS SCHEMATIC IN NATURE AND IS NOT INTENDED FOR USE AS A FORMAL SURVEY.

UNDERGROUND PHONE, ELEC. \$ CABLE

SUPPLY FROM EXISTING UTILITY POLE

EXISTING FIRE HYDRANT —

/— PROPERTY LINE

FLOOD


HAZARDS

DAVID TODER ARCHITECT / CRAFTSMAN

298 Plutarch Road Highland, New York 12528 Town of New Paltz 845-532-8354 fax 845-255-2548 BolderArchitect@aol.com Bolder-Architecture.com

DATE: 1/19/09 PROJECT # 08-38

TITLE SHEET

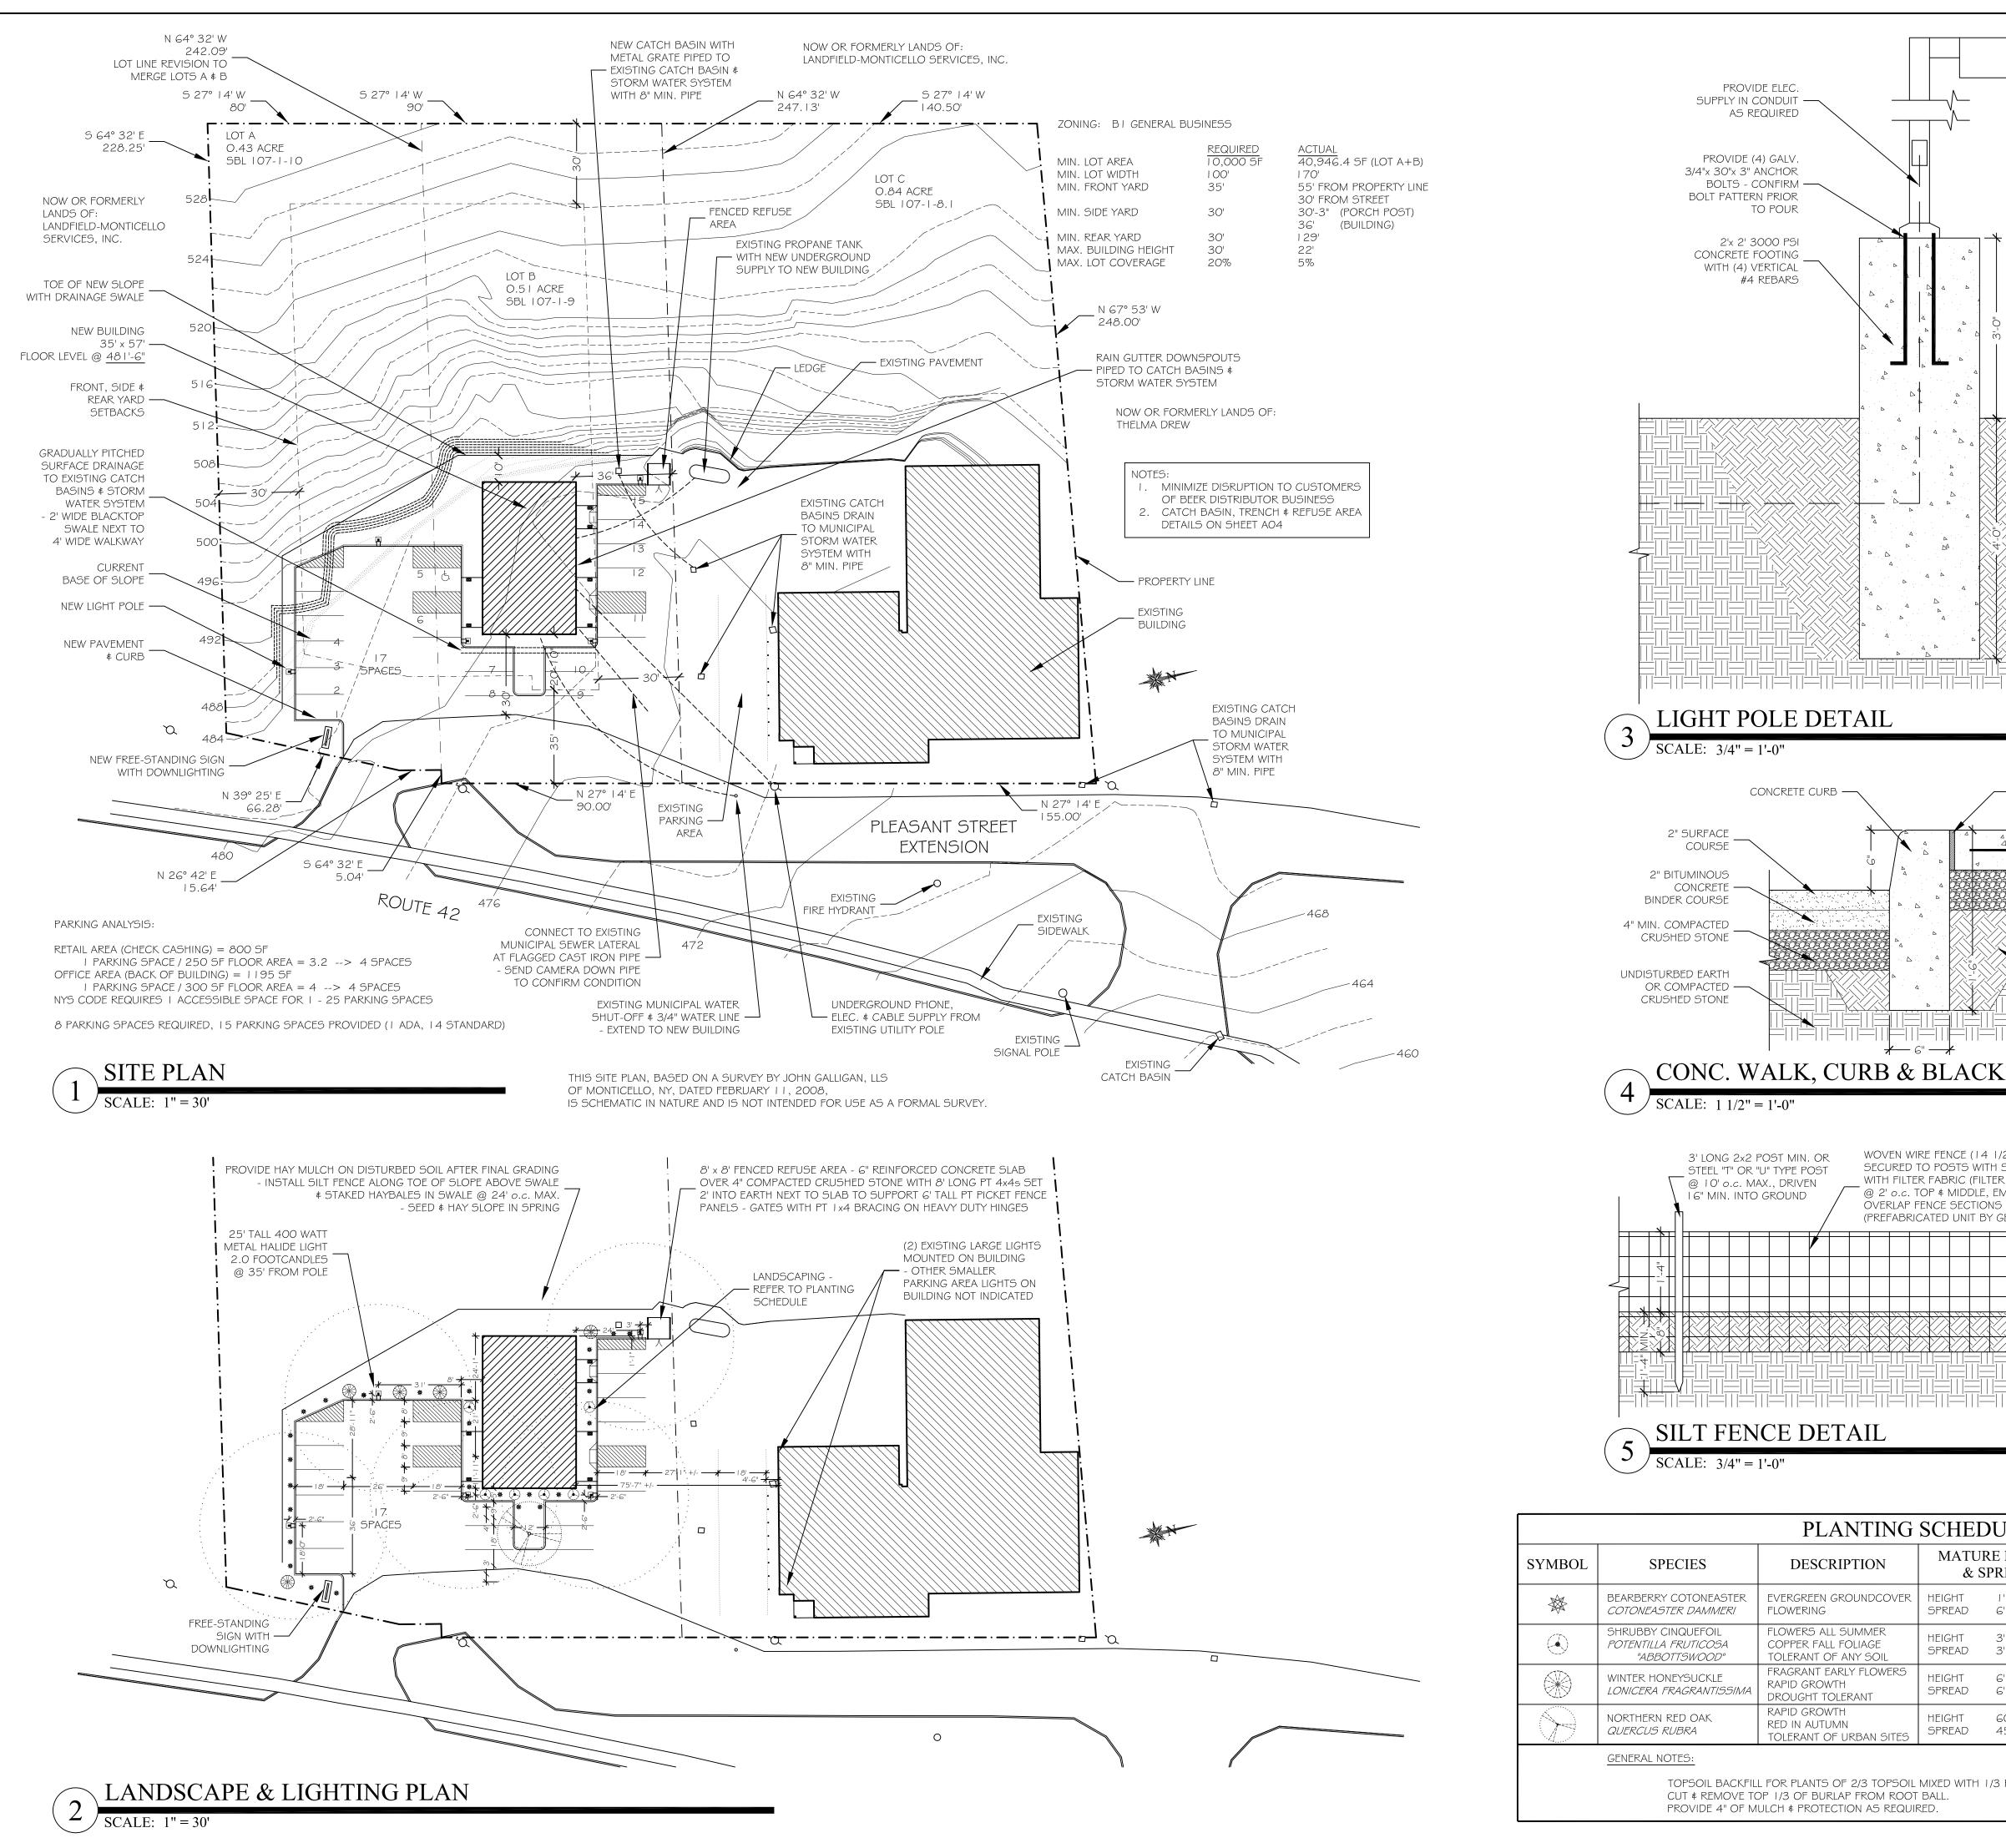

400 WATT METAL HALIDE LIGHT ON 22' TALL 4x4 POLE WITH BRONZE FINISH -25' TOTAL HEIGHT @ LIGHT COMPACTED BACKFILL UNDISTURBED EARTH

— 1/2" EXPANSION JOINT EXTERIOR 4" THICK 4000 PSI CONCRETE SLAB W/ 6x6 #10 W.W.M. -**BROOM FINISH** 4" MIN. COMPACTED CRUSHED STONE - COMPACTED BACKFILL

CONC. WALK, CURB & BLACKTOP DETAIL

WOVEN WIRE FENCE (14 1/2 GAUGE MIN., 6" MESH SPACING MAX.) SECURED TO POSTS WITH STAPLES OR WIRE TIES, WITH FILTER FABRIC (FILTER X OR EQUAL) SECURED TO WIRE FENCE @ 2' o.c. TOP \$ MIDDLE, EMBEDDED 8" MIN. INTO GROUND -OVERLAP FENCE SECTIONS 6" MIN. (PREFABRICATED UNIT BY GEOFAB OR EQUAL)

PLANTING SCHEDULE									
SYMBOL	SPECIES	DESCRIPTION		RE HEIGHT SPREAD	INSTALLED SIZE & SPACING		# OF PLANTS		
	BEARBERRY COTONEASTER COTONEASTER DAMMERI	EVERGREEN GROUNDCOVER FLOWERING	HEIGHT SPREAD	l' - 2' 6' - 10'	HEIGHT SPACING	3" - 4" (4' - 6')	24		
	SHRUBBY CINQUEFOIL FLOWERS ALL SUMMER POTENTILLA FRUTICOSA COPPER FALL FOLIAGE "ABBOTTSWOOD" TOLERANT OF ANY SOIL		HEIGHT SPREAD	3' - 4' 3' - 4'	HEIGHT SPACING	3" - 6" (4' - 6')	6		
WINTER HUNEYSUCKLE I ONICERA ERAGRANTISSIMA RA		FRAGRANT EARLY FLOWERS RAPID GROWTH DROUGHT TOLERANT	HEIGHT SPREAD	6' - 10' 6' - 10'	HEIGHT SPACING	6" - 12" 11' (6' - 8')	5		
	NORTHERN RED OAK QUERCUS RUBRA	RAPID GROWTH RED IN AUTUMN TOLERANT OF URBAN SITES	HEIGHT SPREAD	60' - 75' 45'	HEIGHT SPACING	4' - 5'	I		

TOPSOIL BACKFILL FOR PLANTS OF 2/3 TOPSOIL MIXED WITH 1/3 PEAT MOSS.

COMMERCIAL BUILDING

HUDSON CHECK CASHING

73 PLEASANT STREET EXT.

MONTICELLO, NEW YORK

FOR

VILLAGE OF MONTICELLO

IT IS A VIOLATION OF THE LAW FOR ANY PERSON TO ALTER INFORMATION INCLUDED IN THESE DOCUMENTS IF THESE PLANS HAVE BEEN AFFIXED

WITH THE SEAL OF A LICENSED ARCHITECT REVISION DATE DESCRIPTION

> BOLDER ARCHITECTURE

DAVID TODER ARCHITECT / CRAFTSMAN

298 Plutarch Road Highland, New York 12528 Town of New Paltz 845-532-8354 fax 845-255-2548 BolderArchitect@aol.com Bolder-Architecture.com

DATE: 1/19/09 PROJECT # 08-38

SITE PLANS

DOOR #	NOMINAL SIZE WIDTH x HEIGHT	DOOR				i e						
		AL AL				F	FRAMI	Е	SAD	DLE		NOTES
	x THICKNESS	MATERIAL	TYPE	GLASS	FIRE	MATERIAL	DE1 HEAD	TAIL JAMB	MATERIAL	TYPE	HARDWARE GROUP	
101	3'-0" x 7'-0" x 3/4"	ALUM		YES		ALUM			ALUM		Α	STOREFRONT
102	3'-0" x 7'-0" x 3/4"	ALUM		YES		ALUM			ALUM		Α	STOREFRONT
103	3'-0" x 7'-0" x 3/4"	ALUM		YES		ALUM			ALUM		Α	STOREFRONT
104	3'-0" x 6'-8" x 3/4"	STEEL				STEEL					E	SECURITY - FLUSH METAL
105	3'-0" x 6'-8" x 3/4"	STEEL				STEEL					F	SECURITY - FLUSH METAL
106	3'-0" x 6'-8" x 3/4"	STEEL				STEEL					F	SECURITY - FLUSH METAL
107	2'-4" x 6'-8" x 3/8"	WD				STEEL					С	
108	2'-4" x 6'-8" x 3/8"	WD				STEEL					С	
109	3'-0" x 6'-8" x 3/8"	WD				STEEL					В	
110	3'-0" x 6'-8" x 3/8"	WD				STEEL					В	
111	6'-0" x 6'-8" x 1 3/8"	WD				STEEL					G	PAIR OF (2) 3'-0" x 6'-8" DOORS
112	3'-0" x 6'-8" x 1 3/8"	WD				STEEL					D	
113	3'-0" x 6'-8" x 1 3/8"	WD				STEEL					D	
114	3'-0" x 6'-8" x 3/8"	WD				STEEL					D	

- I. --- = NOT APPLICABLE, ALUM = ALUMINUM, FBG = FIBERGLASS, MARB = MARBLE, VY = VINYL, WD = WOOD.
- 2. ALL INTERIOR DOORS SHALL BE FLUSH SOLID-CORE WOOD WITH STAINED MAHOGANY VENEER & METAL DOOR BUCKS, UNLESS OTHERWISE NOTED.
- 3. CONFIRM DOOR SIZES, SWINGS & HARDWARE PRIOR TO ORDERING.
- 4. STOREFRONT DOOR HARDWARE TO HAVE CLEAR ANODIZED FINISH. INTERIOR DOOR HARDWARE TO HAVE BRUSHED CHROME FINISH. PROVIDE DOOR BUMPERS AS REQUIRED.

DOOR HARDWARE

- A. (1) CONTINUOUS HINGE, (1) ENTRANCE LOCK SET WITH ADA HANDLE & EXTERIOR JAMB-MOUNTED KEYPAD, SELF-CLOSER, PANIC BAR EGRESS, ALUMINUM SADDLE WITH THERMAL BREAK, WEATHERSTRIPPING
- B. (3) HINGES, (1) ADA HANDLE PAIR WITH BED / BATH PRIVACY LOCK
- C. (3) HINGES, (1) ADA HANDLE PAIR WITH PASSAGE LATCH
- D. (3) HINGES, (1) ADA HANDLE PAIR WITH KEYED LOCK
- E. (3) HINGES, (1) ELECTRONIC \$ KEYED ENTRANCE LOCK SET WITH ADA HANDLE PAIR, SELF-CLOSER, MAGLOCK MANTRAP
- F. (3) HINGES, (1) ADA HANDLE PAIR WITH KEYED LOCK, SELF-CLOSER, MAGLOCK MANTRAP
- G. (6) HINGES, (2) DUMMY ADA HANDLES, (2) BALL LATCHES

\mathbb{W}	INDOW	SCHEDULE				
WINDOW ROUGH OPENING TYPE W x H		NOTES				
А	2'-8" x 4'-4"	FIXED				
В	2'-4" x 4'-4"	FIXED				
BT	2'-4" x 4'-4"	FIXED - TEMPERED				
С	1'-4" x 7'-8"	FIXED - TEMPERED				
D	3'-0" x 0'-8"	FIXED				
	GENERAL NOTES					

- WINDOW UNITS TO BE MANUFACTURED BY BESAM WINDOWS & DOORS, CLEAR ANODIZED STOREFRONT FRAMES WITH THERMAL BREAKS, WITH DOUBLE PANE INSULATING GLASS (U-VALUE = 0.32+/-) \$ NO GRILLES, UNLESS OTHERWISE NOTED. REFER TO ELEVATIONS ON SHEET AO2.
- 2. CONFIRM WINDOW SIZES \$ SPECIFICATIONS PRIOR TO ORDERING.
- 3. WINDOW OPENING HEAD HEIGHT AT 8'-0".

COMMERCIAL BUILDING

FOR

HUDSON CHECK CASHING

73 PLEASANT STREET EXT. MONTICELLO, NEW YORK

VILLAGE OF MONTICELLO

IT IS A VIOLATION OF THE LAW FOR ANY PERSON TO ALTER INFORMATION INCLUDED IN THESE DOCUMENTS IF THESE PLANS HAVE BEEN AFFIXED WITH THE SEAL OF A LICENSED ARCHITECT


REVISION	DATE	DESCRIPTION

GENERAL NOTES


- . ALL EXTERIOR WALLS TO BE 11" THICK INSULATED CONCRETE FORMS (ICFs). ALL INTERIOR WALLS TO BE 2x 4 SPF STUDS @ 16" o.c. WITH PT BOTTOM PLATE UNLESS OTHERWISE NOTED.
- B. DIMENSIONS ARE FROM FRAMING OR ICF TO FRAMING.
- . PROVIDE FORCED AIR HEATING SYSTEM WITH FRESH AIR INTAKE & EXHAUST VENTING.
- . CENTER CLOSET DOORS UNLESS OTHERWISE NOTED. EDGE OF OTHER INTERIOR DOORS 4" FROM WALL.
- NOMINAL HEAD HEIGHTS DOORS = 6'-8", WINDOWS =
- SMOKE & CO DETECTORS SHOWN ON ELEC. PLAN EO I.

KEYED NOTES

- PROVIDE (5) SHELVES
- 2 REFER TO SHEET A04 FOR INTERIOR ELEVATIONS
- 3 INTERIOR ELEVATION ON PLUMBING RISER DIAGRAM 3/A03

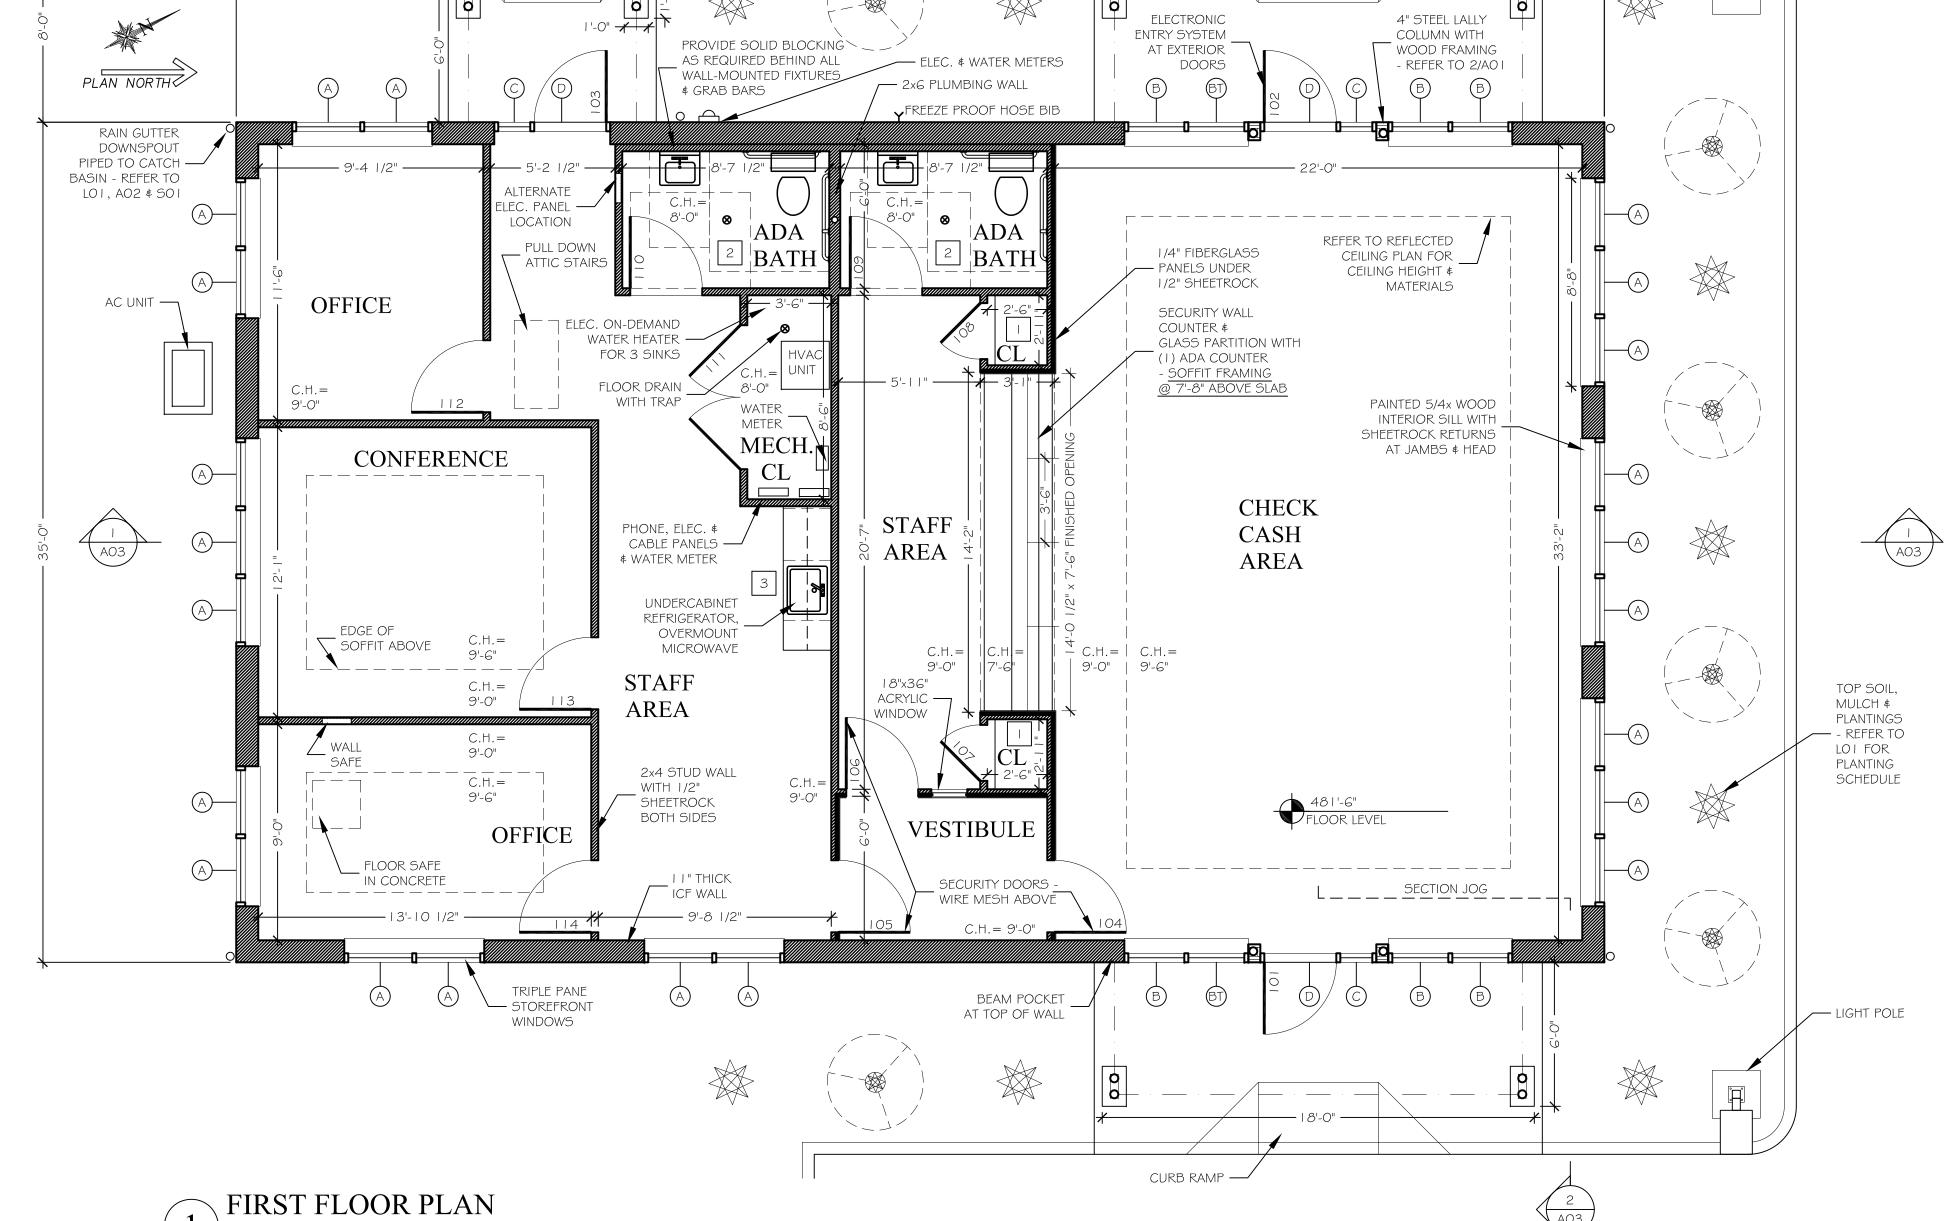

/— RAISE GRADE HERE

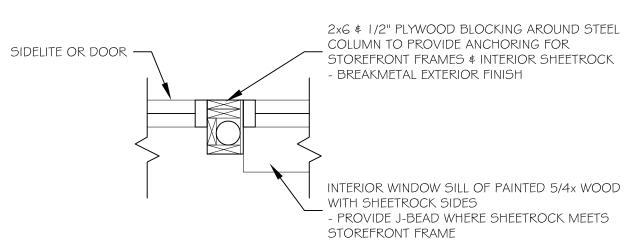

LALLY COLUMN DETAIL - PLAN VIEW


BOLDER ARCHITECTURE


DAVID TODER ARCHITECT / CRAFTSMAN


298 Plutarch Road Highland, New York 12528 Town of New Paltz 845-532-8354 fax 845-255-2548 BolderArchitect@aol.com Bolder-Architecture.com

DATE: 1/19/09 PROJECT # 08-38

FLOOR PLAN & SCHEDULES

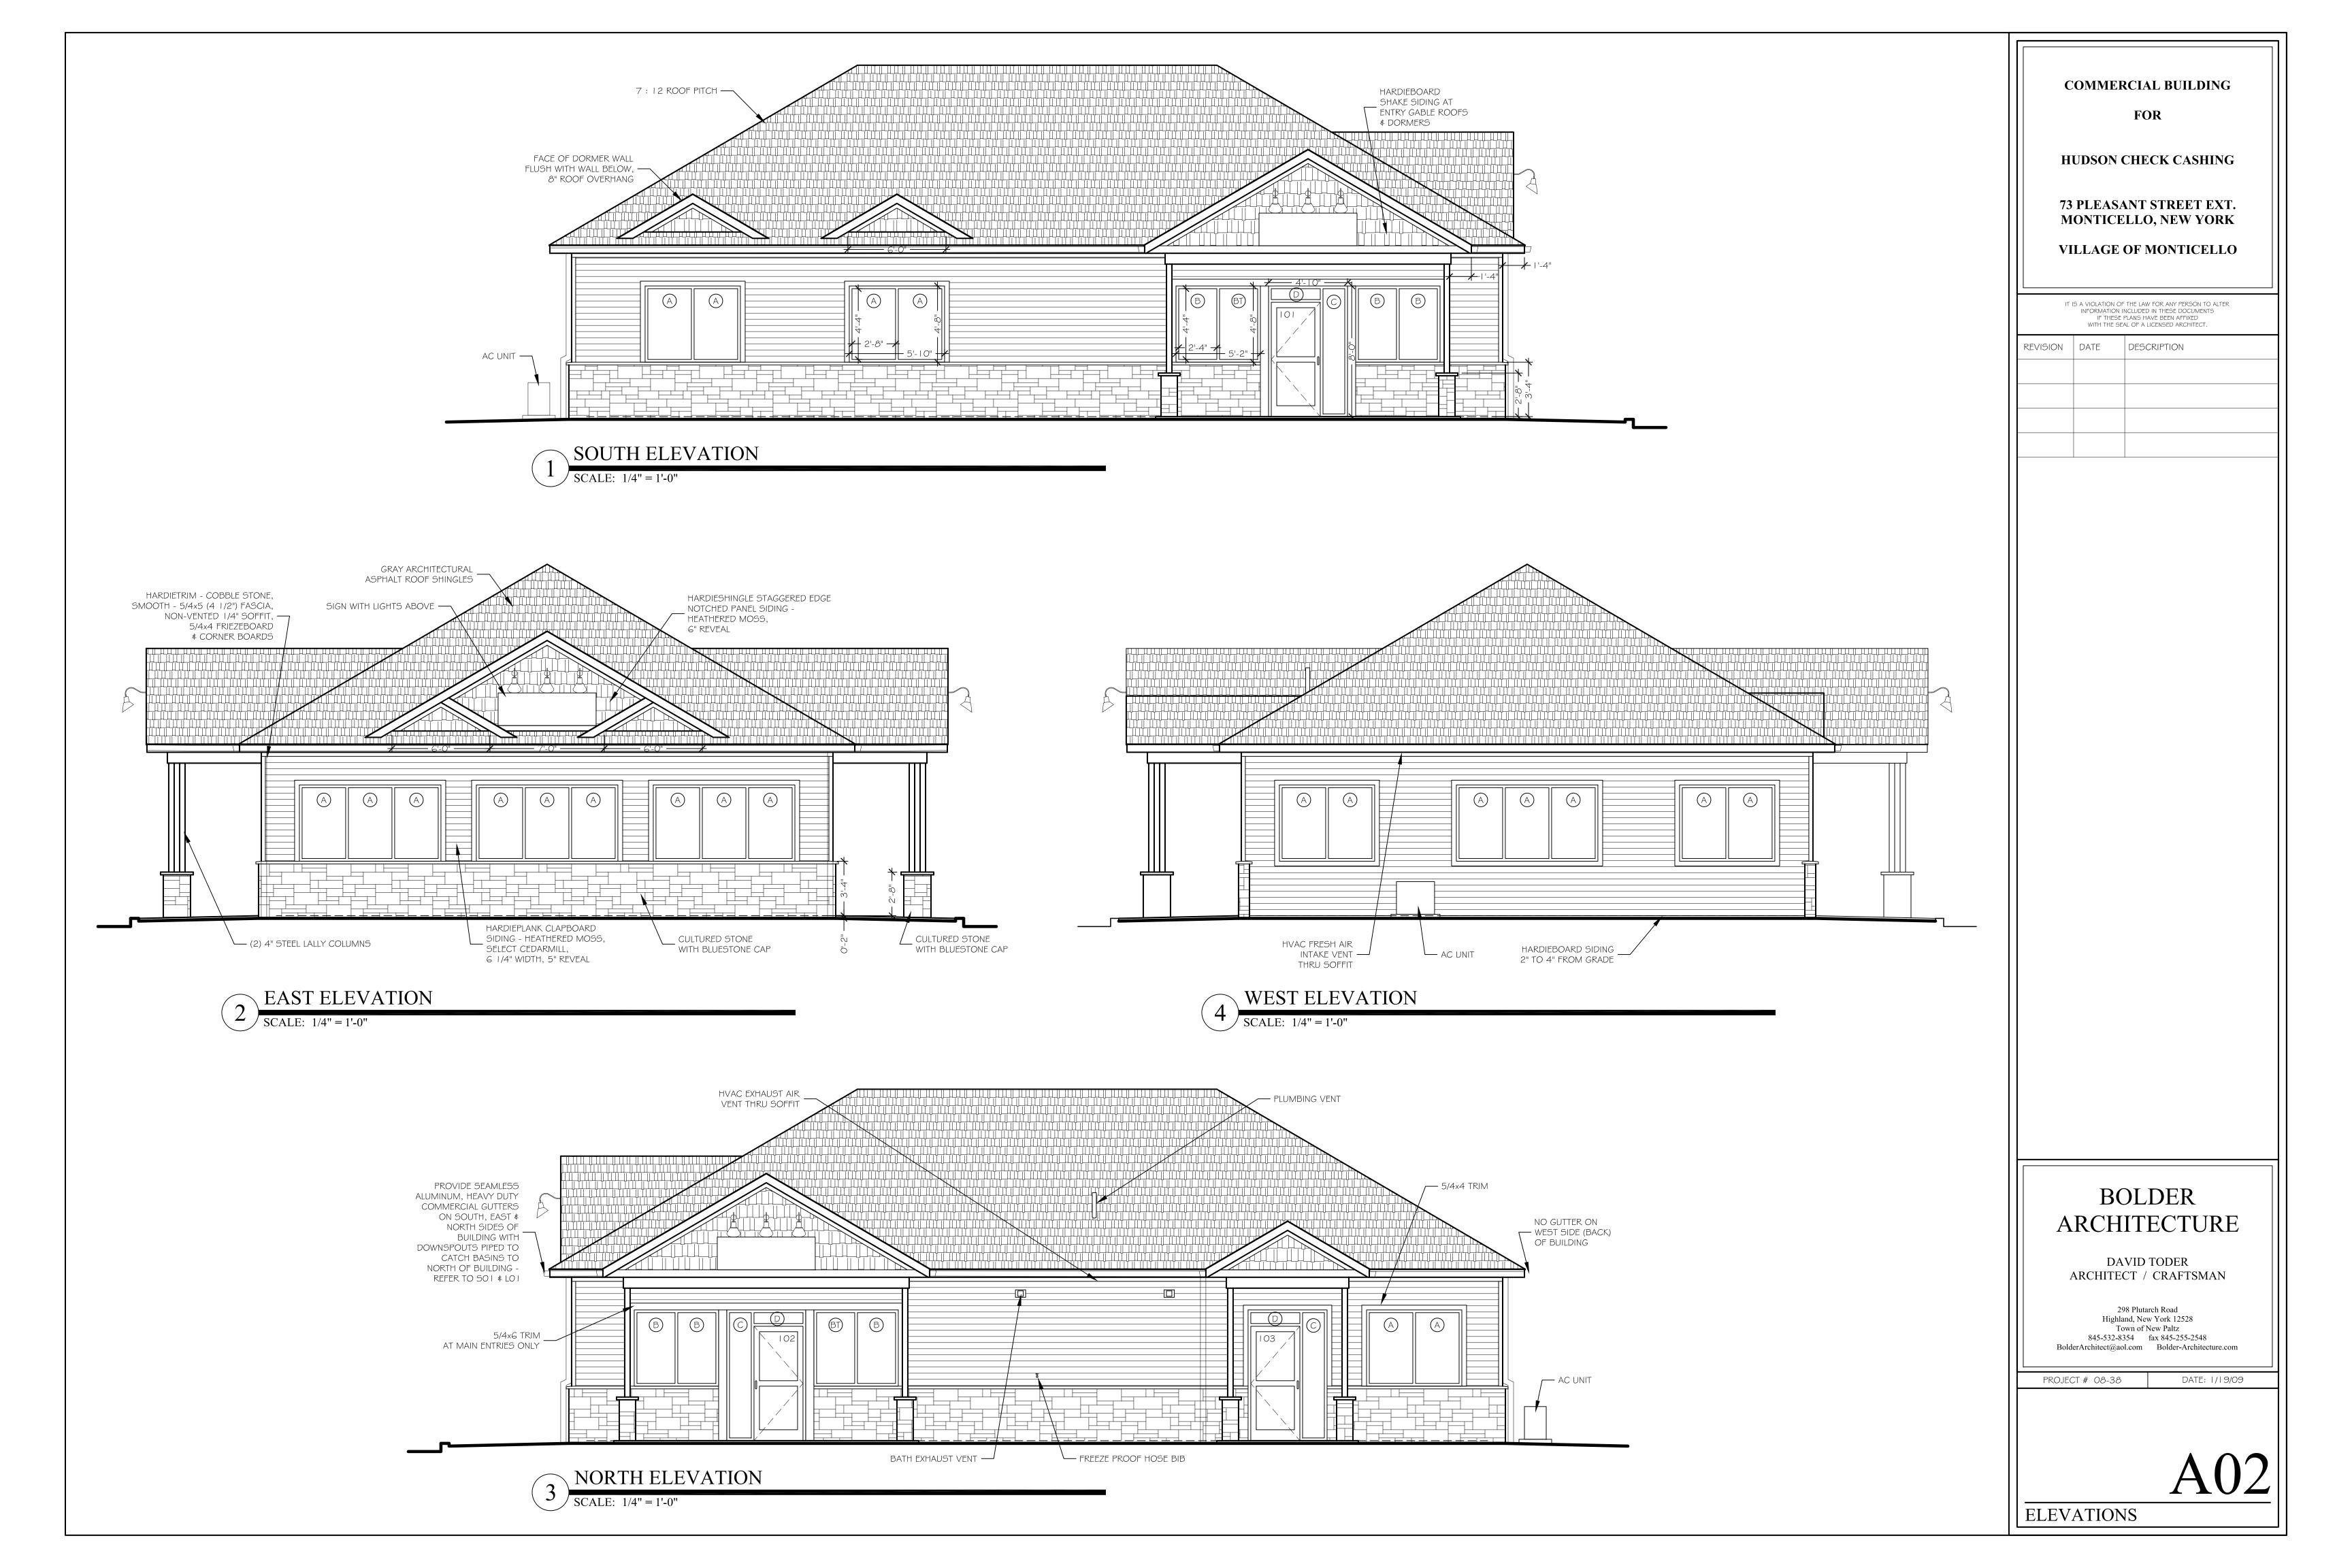

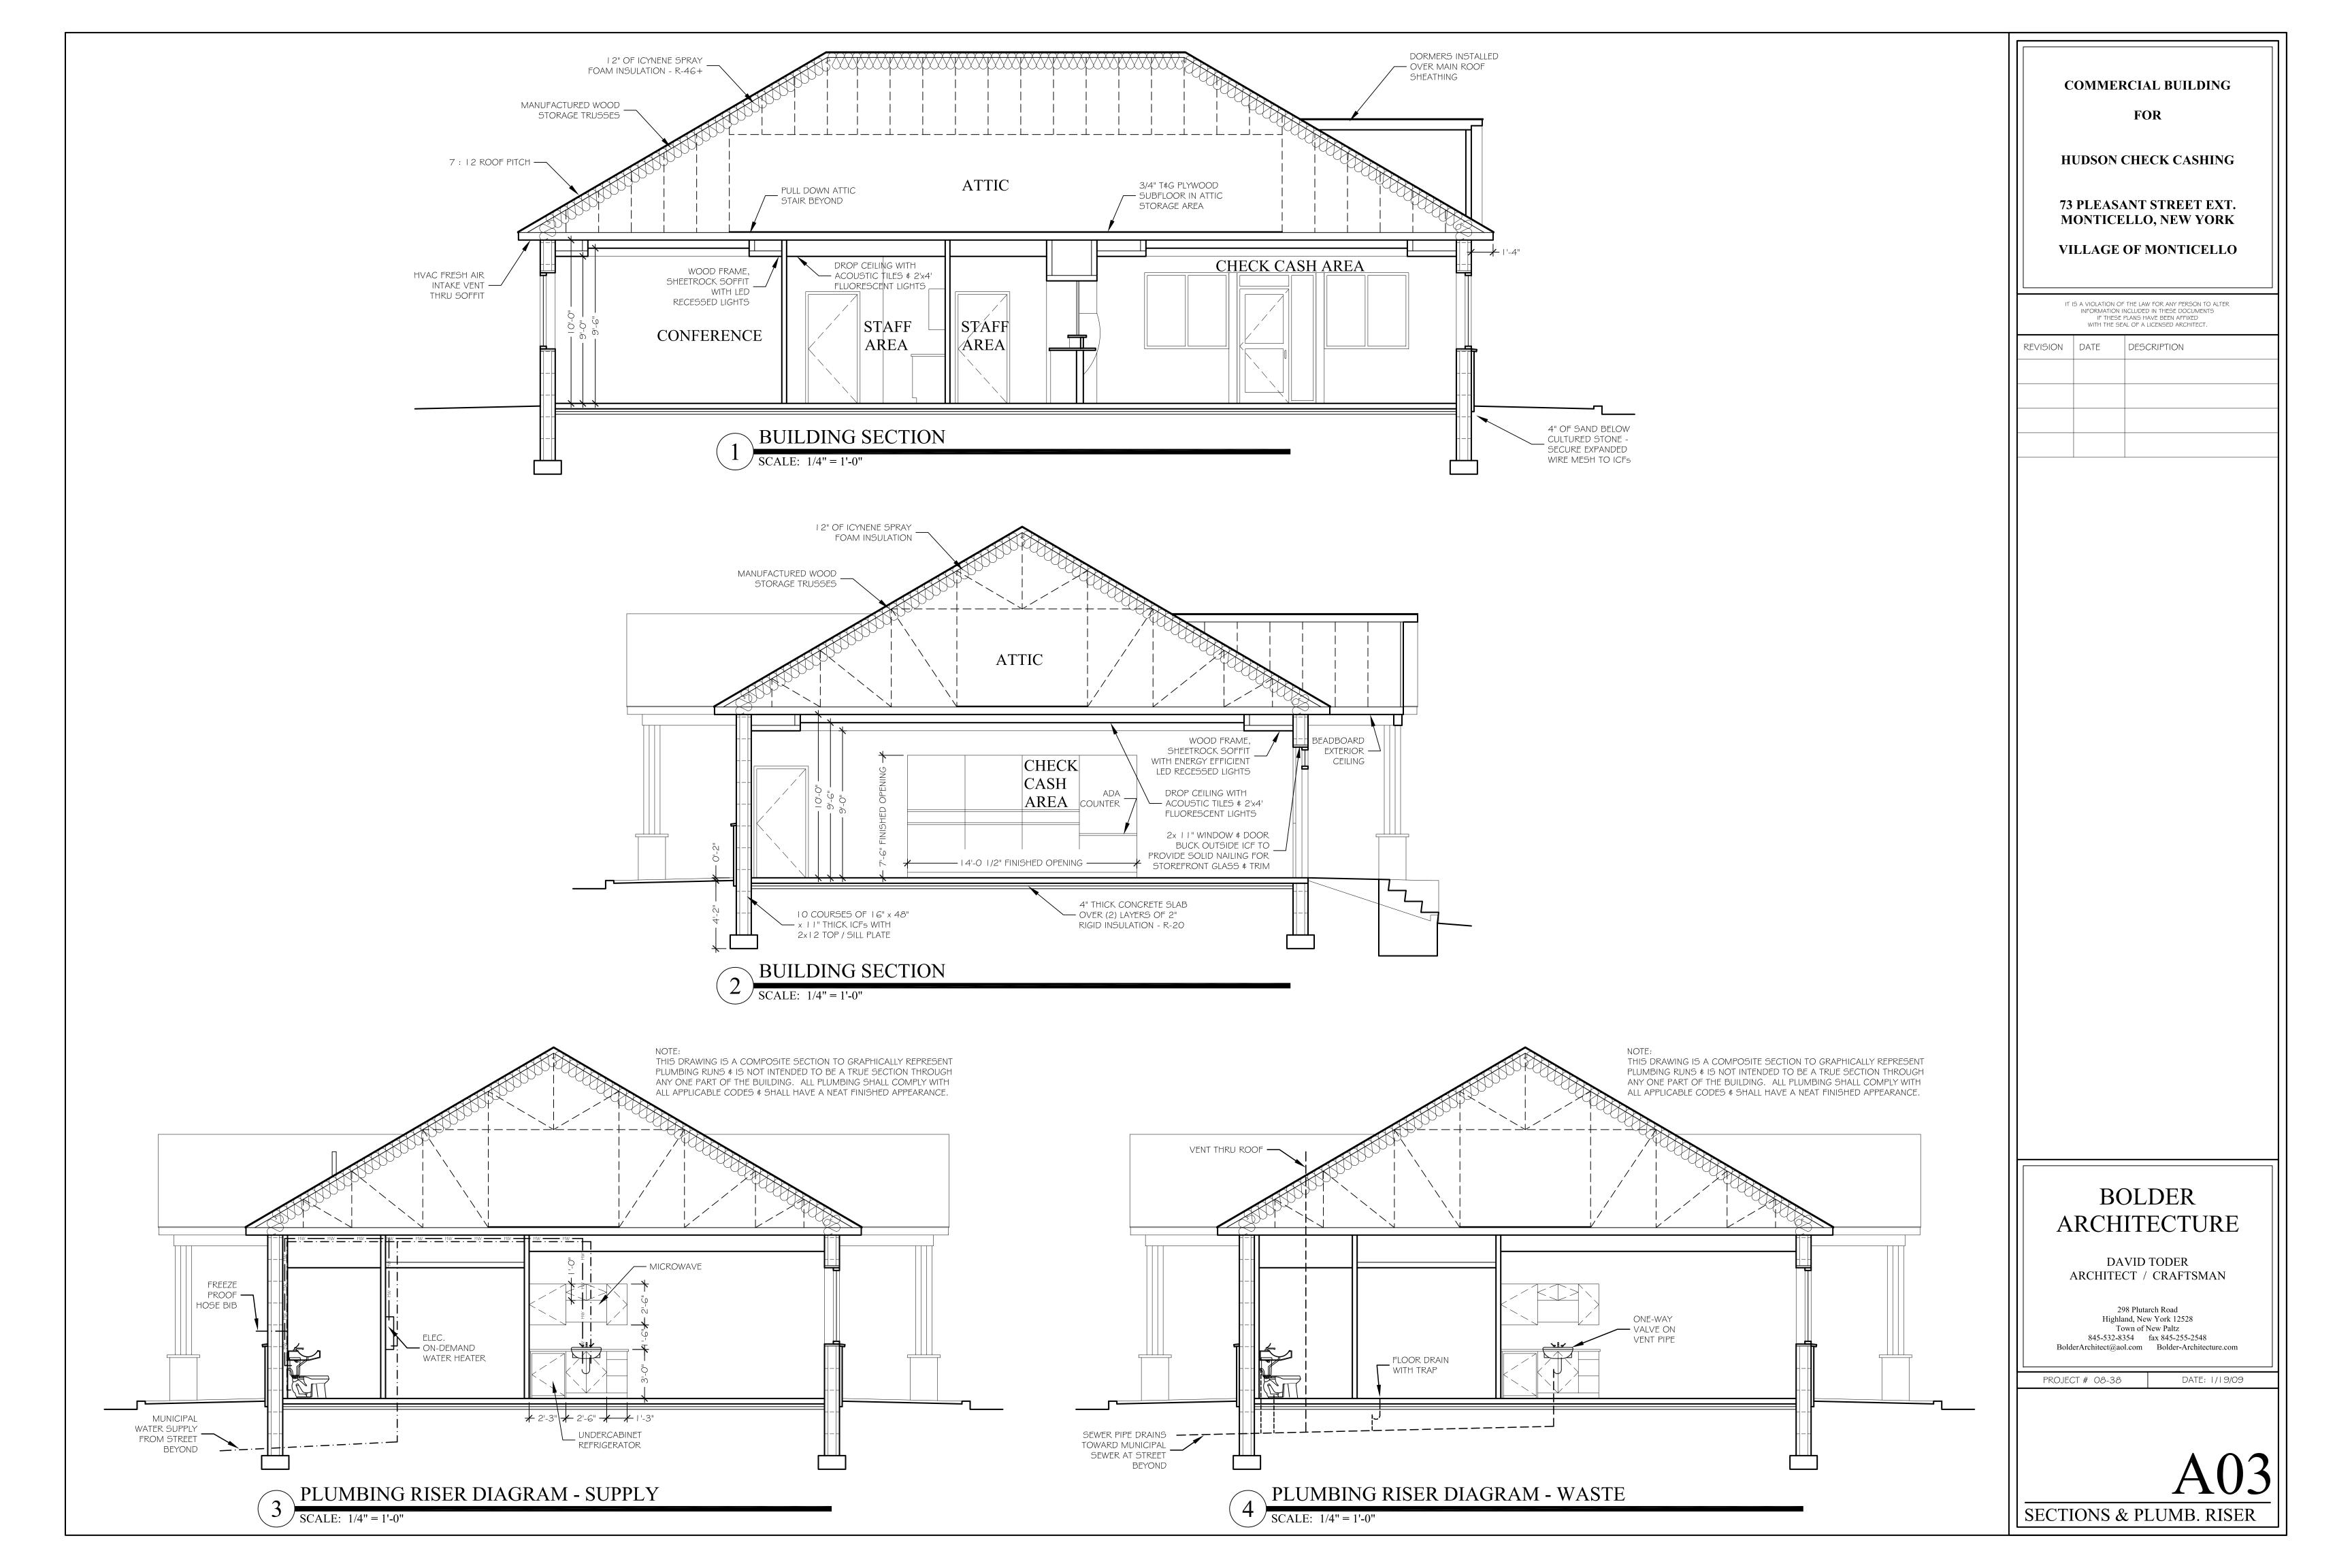

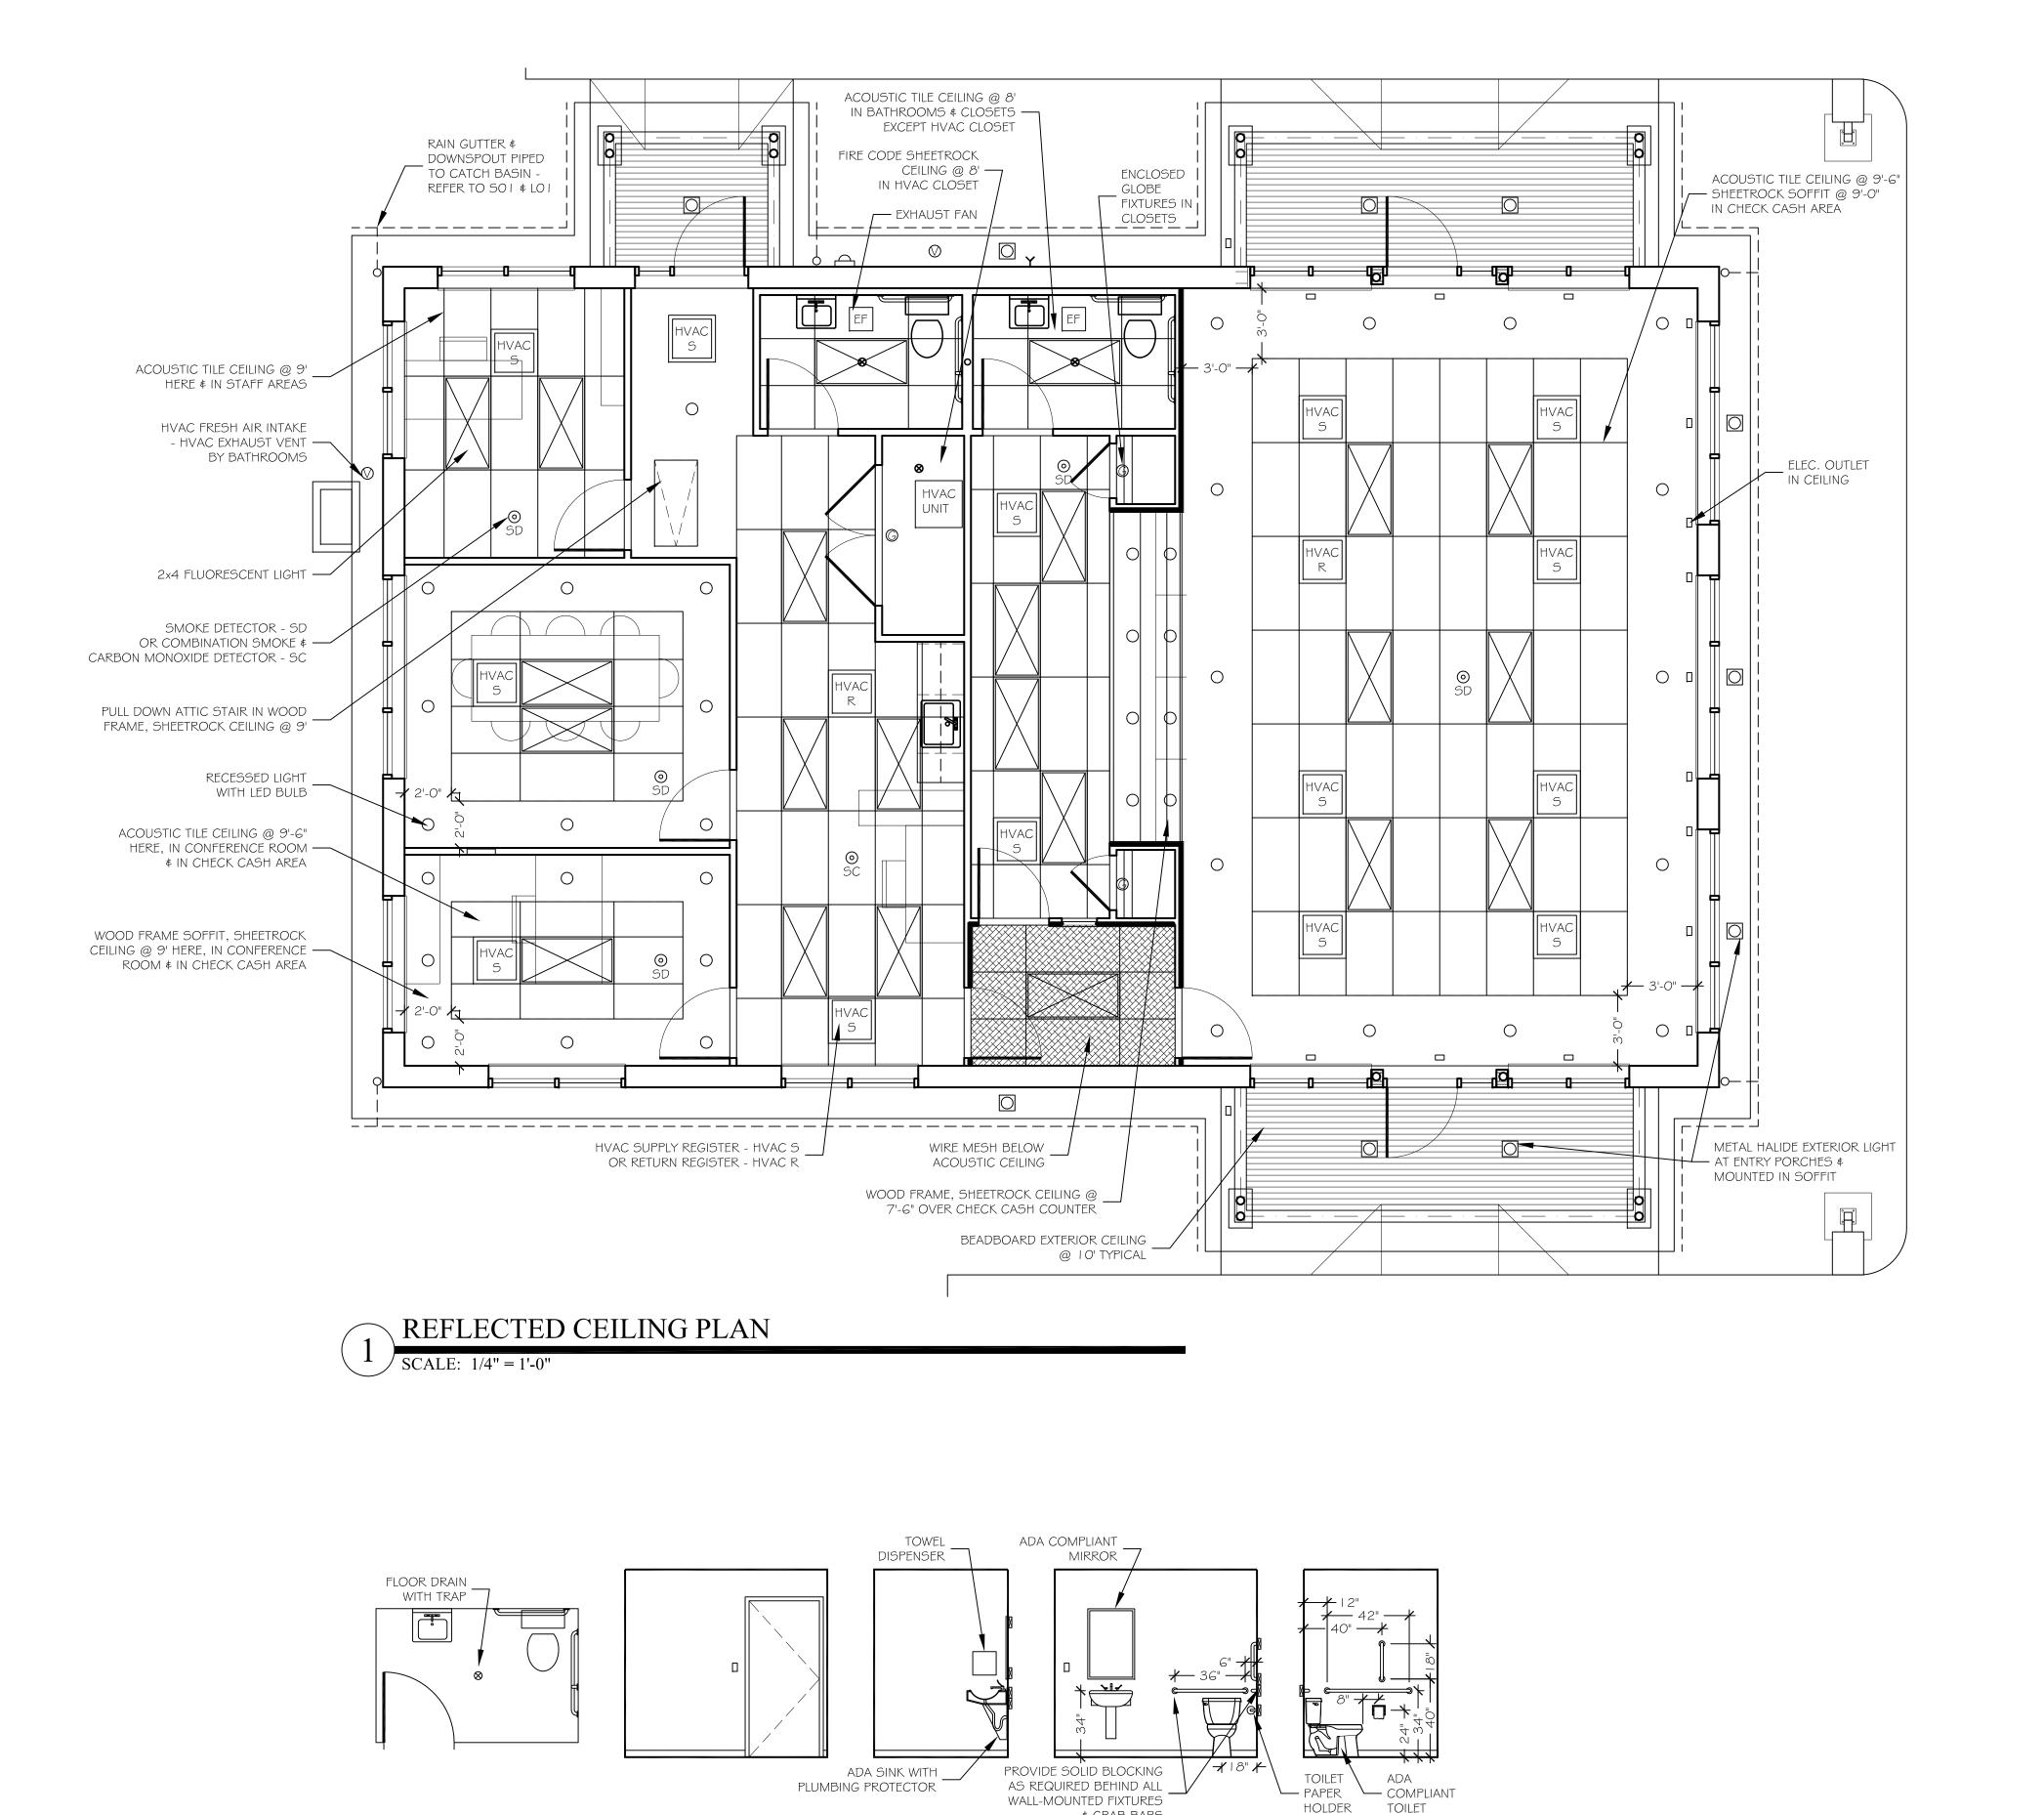

₿ GRAB BARS


ADA BATH PLAN & INTERIOR ELEVATIONS

 $\int SCALE: 1/4" = 1'-0"$

PT 2x4 SCREWED TO 4x4 TO SUPPORT — — BOLLARDS BACK FENCE PANEL 6' TALL x 8' LONG — PT PICKET FENCE SECTIONS 6" CONCRETE SLAB REINFORCED WITH 6×6 #10 W.W.M. -OVER 4" COMPACTED CRUSHED STONE GATES OF PT FENCE 8' LONG PT 4x4s SECTION CUT IN HALF SET 2' INTO EARTH WITH PT 1x4 BRACING ON (3) HEAVY DUTY HINGES EACH WITH LOCKABLE HASP


REFUSE AREA PLAN

SCALE: 1/4'' = 1'-0''

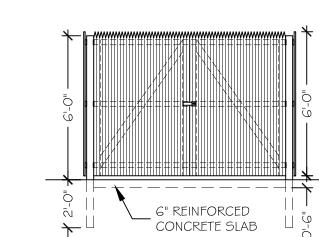


REFUSE AREA ELEVATION

SCALE: 1/4" = 1'-0"

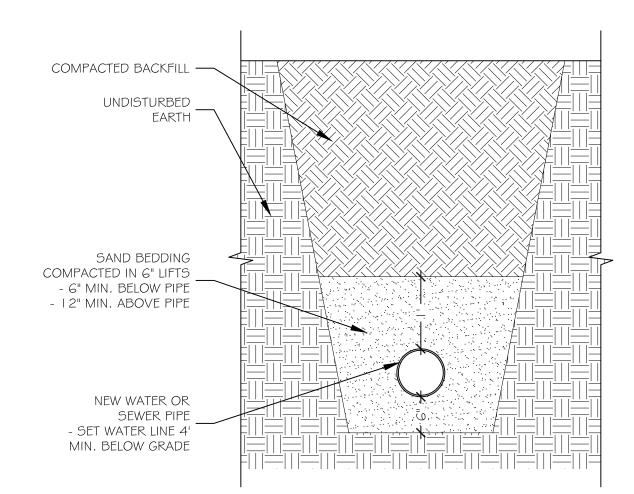

TRENCH DETAIL

SCALE: 3/4'' = 1'-0

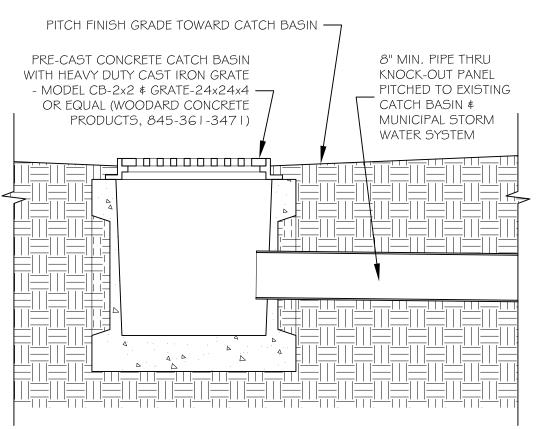

CATCH BASIN DETAIL

SCALE: 3/4'' = 1'-0''

COMMERCIAL BUILDING

HUDSON CHECK CASHING

FOR

73 PLEASANT STREET EXT.

VILLAGE OF MONTICELLO

MONTICELLO, NEW YORK

IT IS A VIOLATION OF THE LAW FOR ANY PERSON TO ALTER INFORMATION INCLUDED IN THESE DOCUMENTS IF THESE PLANS HAVE BEEN AFFIXED WITH THE SEAL OF A LICENSED ARCHITECT.

REVISION DATE DESCRIPTION


BOLDER ARCHITECTURE


DAVID TODER ARCHITECT / CRAFTSMAN


298 Plutarch Road
Highland, New York 12528
Town of New Paltz
845-532-8354 fax 845-255-2548
BolderArchitect@aol.com Bolder-Architecture.com

PROJECT # 08-38 DATE: 1/19/09

A04
REFL. CEIL., ELEVS, DETAILS

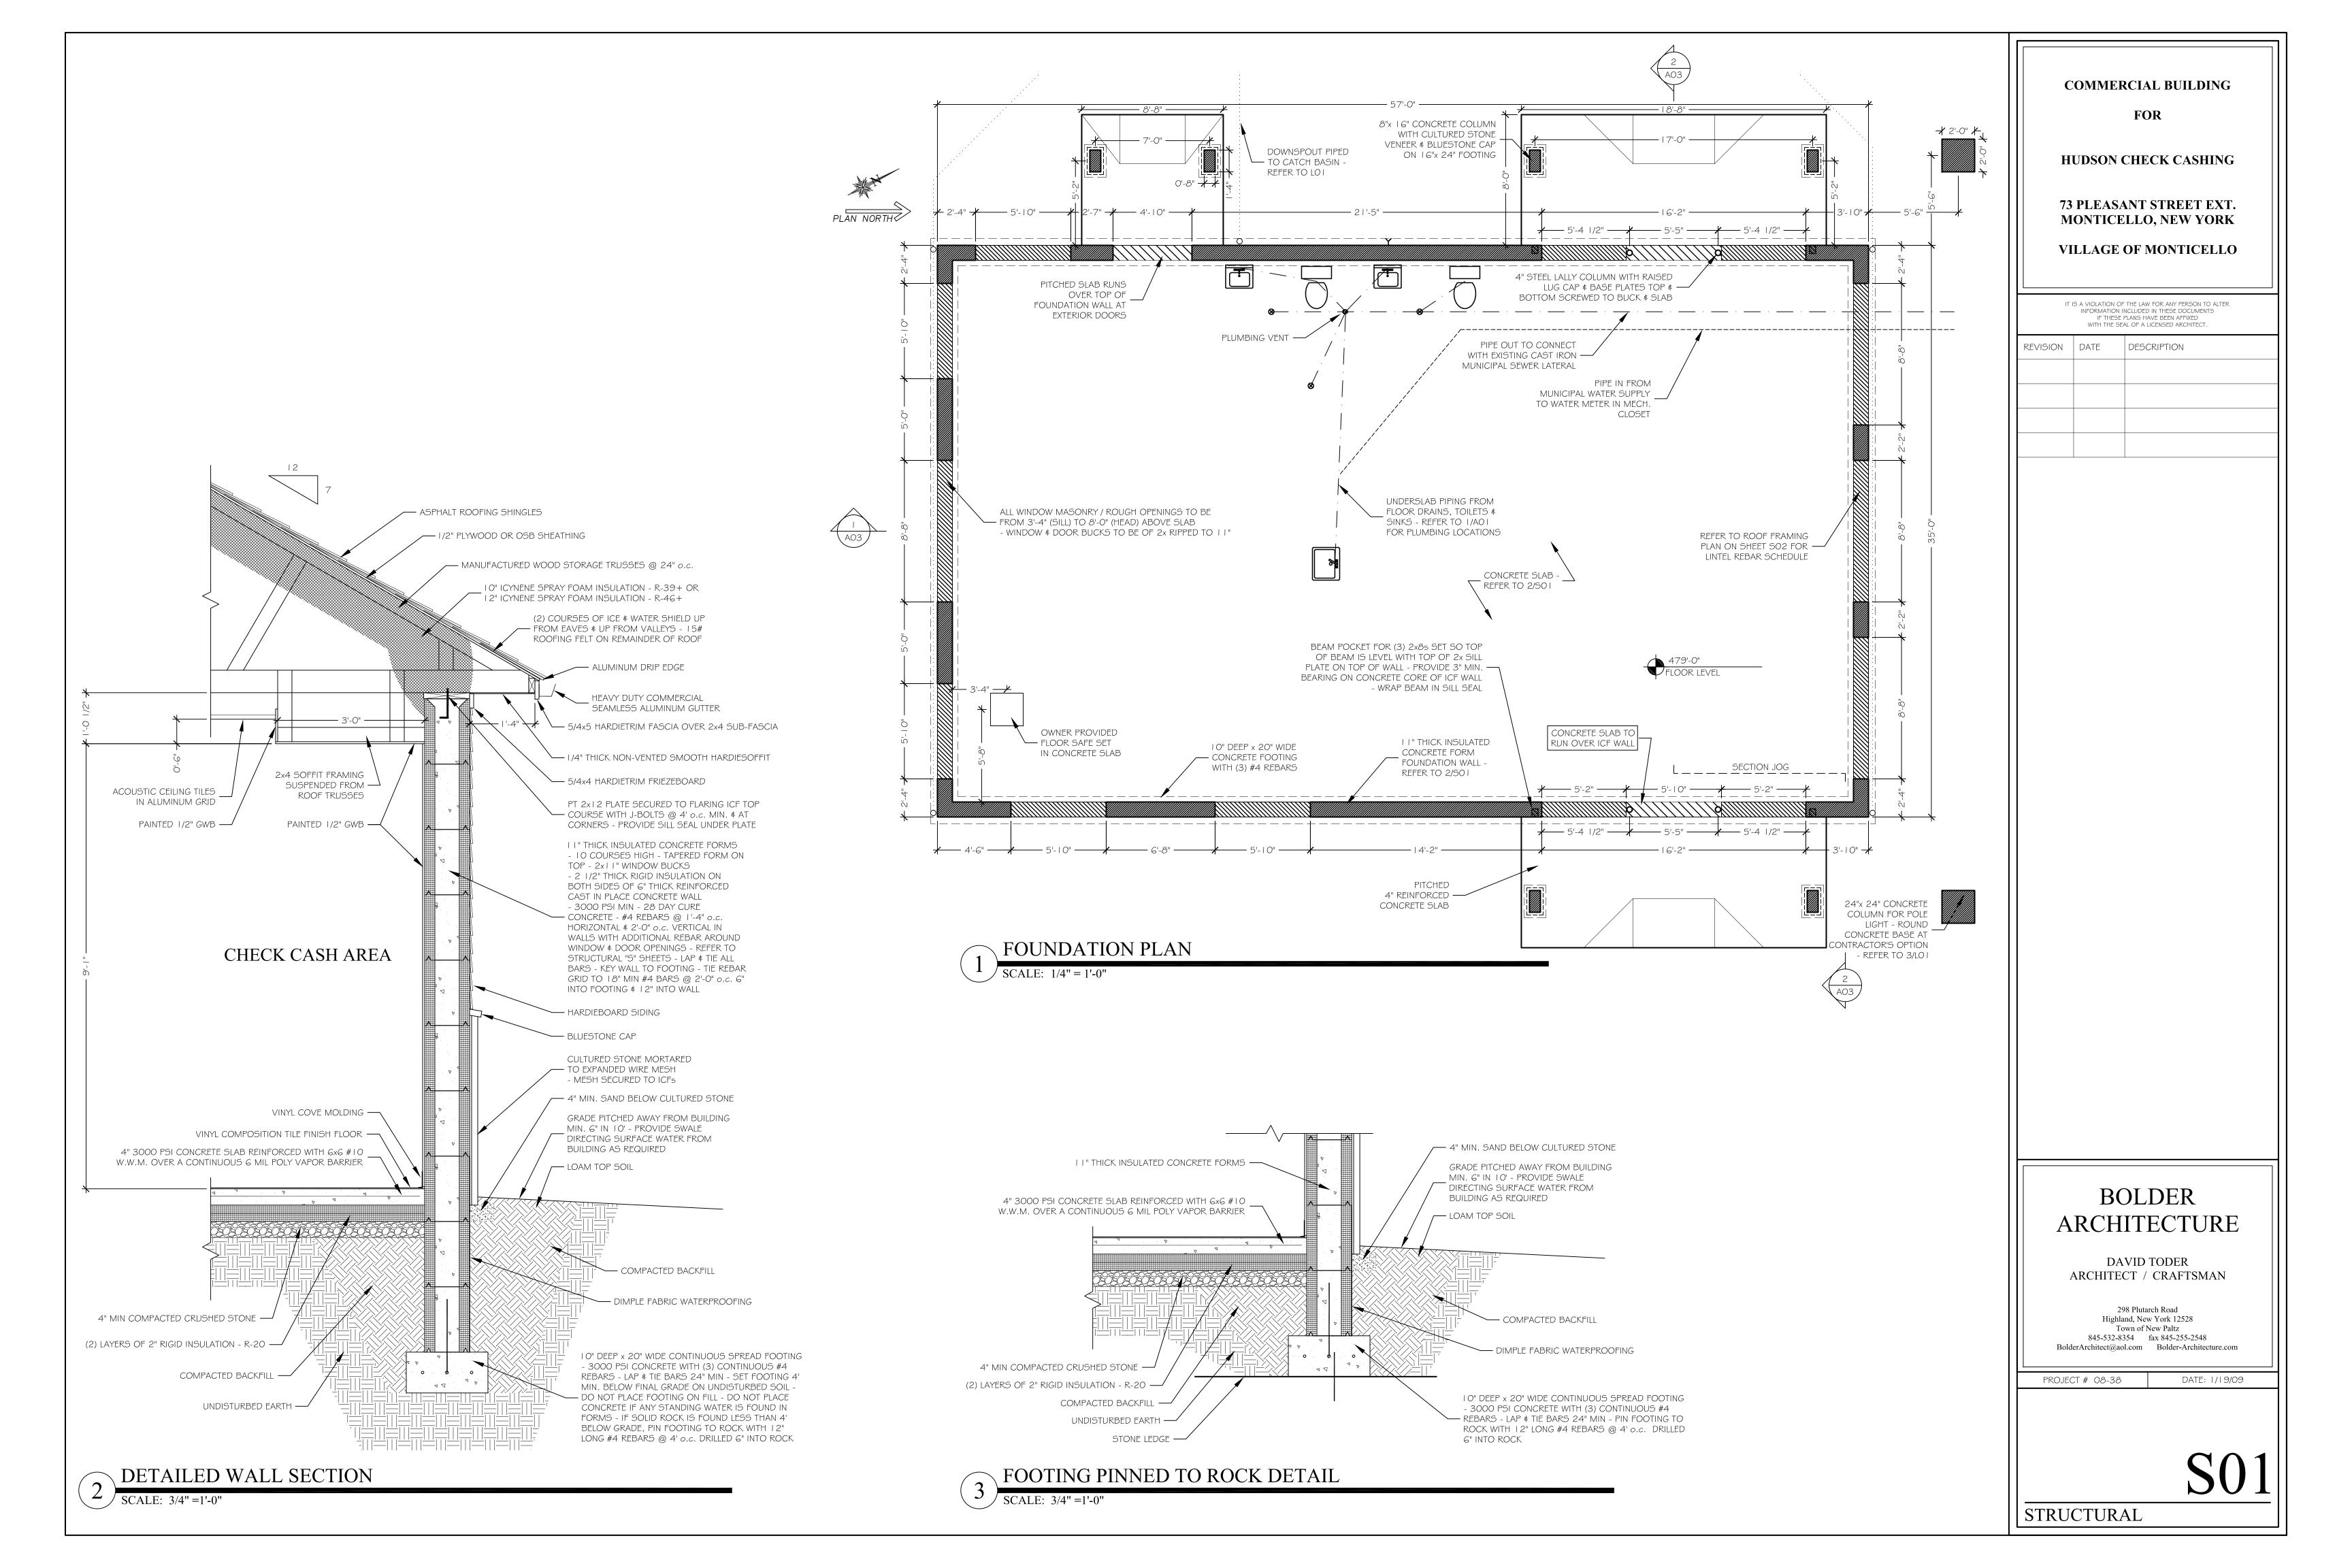

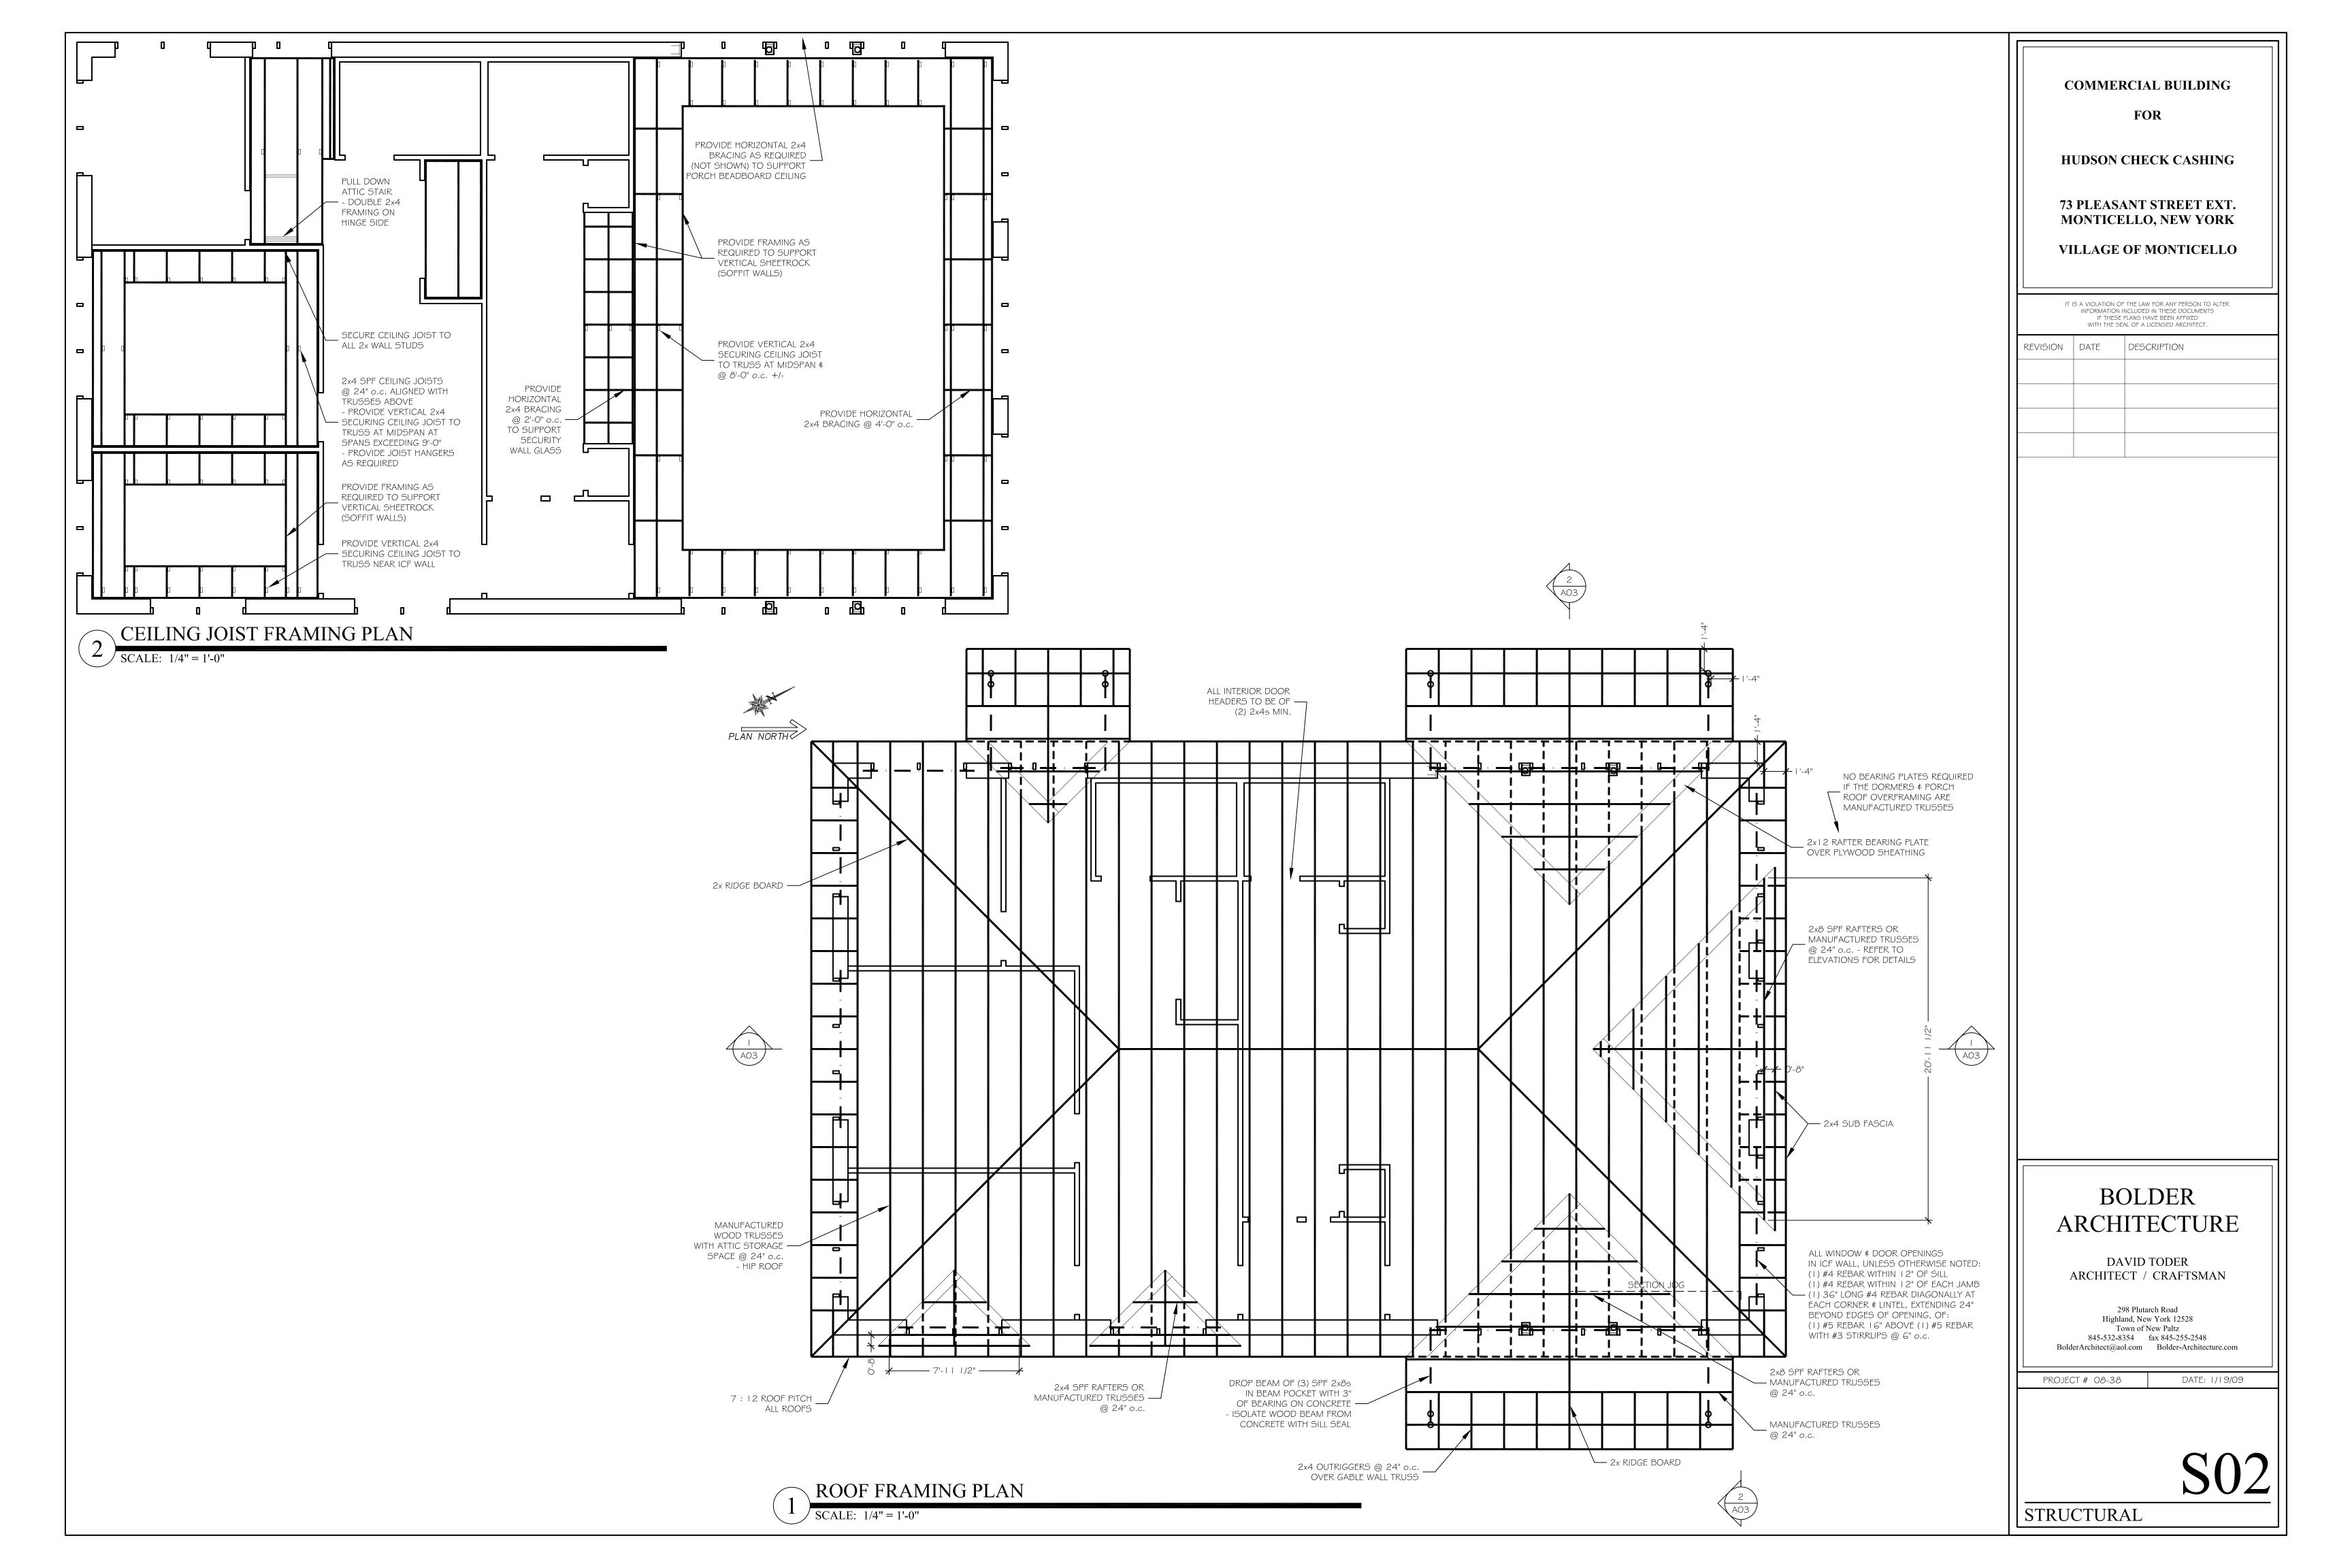

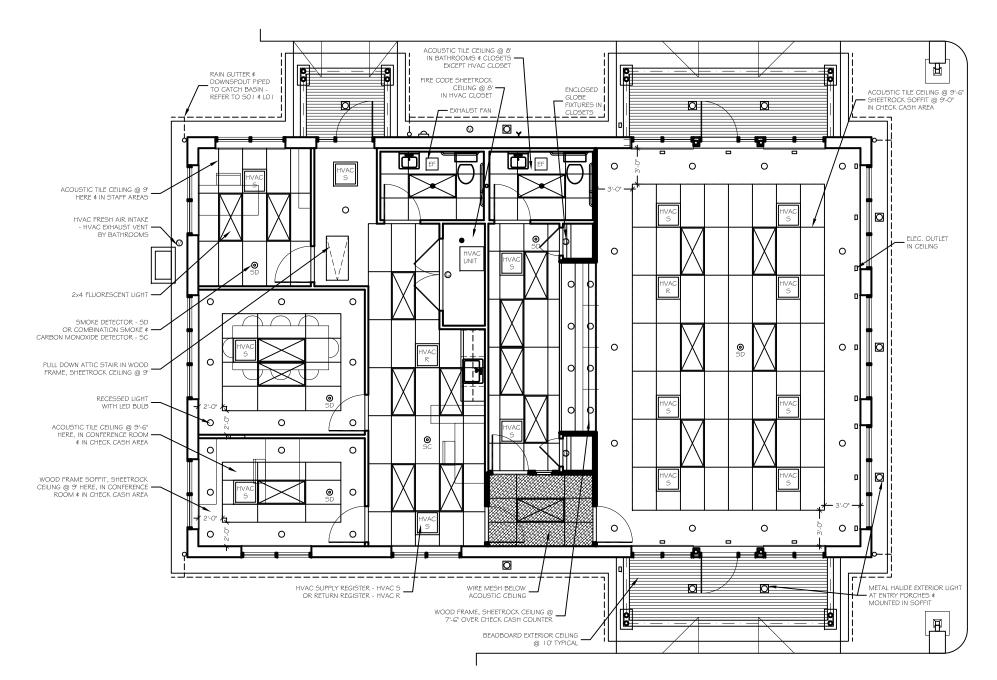


REFLECTED CEILING PLAN (FULL SCALE PLAN ON A04) SCALE: 1/8" = 1'-0"

ELECTRICAL EQUIPMENT LEGEND							
SYMBOL	DESCRIPTION	SYMBOL	DESCRIPTION				
- - - - - - - -	SURFACE MOUNT LIGHT W/ COMPACT FLUORESCENT BULB - ENCLOSED GLOBE	\$	SINGLE POLE SWITCH W/ COVER PLATE				
÷	6" RECESSED LIGHT W/ LIGHT EMITING DIODE BULB	\$3	THREE WAY SWITCH W/ COVER PLATE				
		\ominus	DUPLEX RECEPTACLE W/ COVER PLATE - 20 AMP.				
$\left \begin{array}{c} - \downarrow \\ - \downarrow_F \end{array} \right $	2' x 4' FLUORESCENT LIGHT IN ACOUSTIC CEILING GRID	\bigoplus_{G}	DUPLEX RECEPTACLE W/ GROUND FAULT CIRCUIT INTERRUPTER W/ COVER PLATE - 20 AMP.				
			WATERPROOF DUPLEX RECEPTACLE W/ GROUND FAULT CIRCUIT INTERRUPTER - 20 AMP.				
- \ -	EXTERIOR CEILING LIGHT - 100 WATT METAL HALIDE - RUUD LIGHTING #MCL7410	Фс	CEILING-MOUNTED DUPLEX RECEPTACLE W/ COVER PLATE - 20 AMP PROVIDE GROUND FAULT CIRCUIT INTERRUPTER FOR EXTERIOR LOCATIONS				
-ф _г	EXTERIOR POLE LIGHT - 400 WATT METAL HALIDE - RUUD LIGHTING #VPR2494 ON 22' POLE #PS4S22C BZ	\prec	COMMUNICATIONS OUTLET - PHONE, CABLE, DATA - PROVIDE PHONE LINE & CO-AXIAL CABLE - CAT V - RUN ALL TO PHONE / CABLE INTERFACE JUNCTION				
-\$ _D	EXTERIOR SIGN LIGHT - 100 WATT METAL HALIDE - GOOSENECK - PRIMELITE #20-850-100MH	SD	SMOKE DETECTOR - INTERCONNECTED WITH ALL OTHER SMOKE & CARBON MONOXIDE DETECTORS				
9	EXHAUST FAN / LIGHT	Sc	COMBINATION SMOKE & CARBON MONOXIDE DETECTOR - INTERCONNECTED WITH ALL OTHER SMOKE & CARBON MONOXIDE DETECTORS				
	ELECTRICAL PANEL	EXIT	EMERGENCY EXIT SIGN \$ LIGHTS - BATTERY BACK-UP \$ INTERCONNECTED WITH ALL OTHER FIRE SAFETY SYSTEMS				

GENERAL NOTES

- A. ELECTRICAL WORK TO COMPLY WITH ALL APPLICABLE CODES & REGULATIONS.
- B. COVERPLATES TO BE WHITE.
- C. ALL LIGHTS IN CLOSETS TO HAVE ENCLOSED GLOBE
- D. PROVIDE ELEC. SUPPLY AS REQUIRED TO ALL APPLIANCES & MECHANICAL UNITS INCLUDING MICROWAVE, UNDERCABINET REFRIGERATOR, ON-DEMAND HOT WATER HEATER, HVAC UNITS & CASHIER STATIONS.
- E. PROVIDE LIGHTS & SWITCH IN ATTIC AS REQUIRED.
- F. OWNER'S ALARM CONTRACTOR SHALL PROVIDE ALL SYSTEM DOCUMENTATION, ELEMENTS & WIRING AS

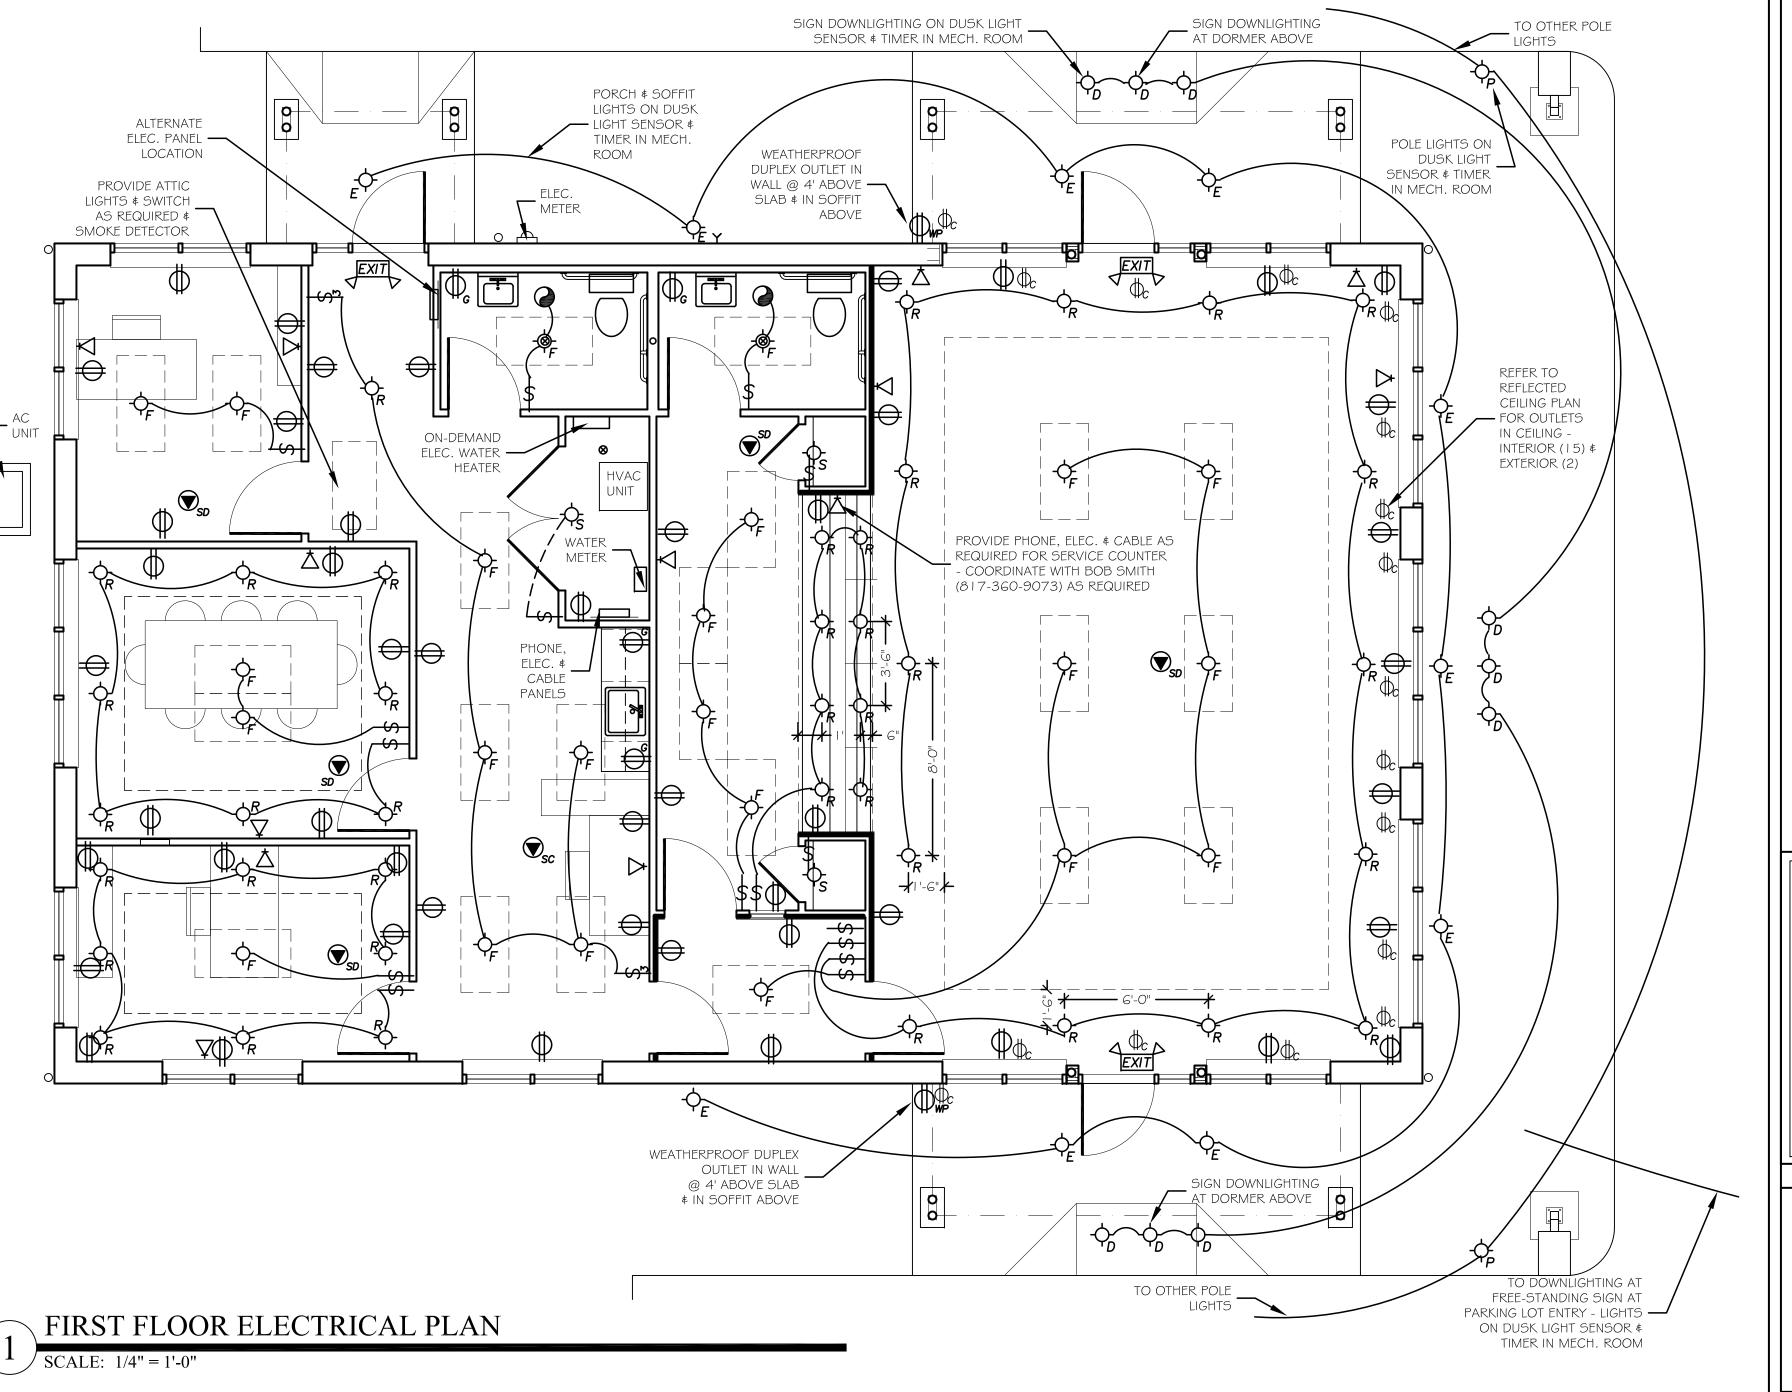

COMMERCIAL BUILDING

FOR

HUDSON CHECK CASHING

73 PLEASANT STREET EXT. MONTICELLO, NEW YORK

VILLAGE OF MONTICELLO

IT IS A VIOLATION OF THE LAW FOR ANY PERSON TO ALTER INFORMATION INCLUDED IN THESE DOCUMENTS IF THESE PLANS HAVE BEEN AFFIXED WITH THE SEAL OF A LICENSED ARCHITECT.

REVISION	DATE	DESCRIPTION

BOLDER ARCHITECTURE

DAVID TODER ARCHITECT / CRAFTSMAN

298 Plutarch Road
Highland, New York 12528
Town of New Paltz
845-532-8354 fax 845-255-2548
BolderArchitect@aol.com Bolder-Architecture.com

PROJECT # 08-38 DATE: 1/19/09

E0

ELECTRICAL